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# **BIDDER'S CERTIFICATION**

This is to certify that I have received from the canvasser of the Commission on Audit, Regional Office No. IX, this City, a copy of Canvass/Bid No.  $\underline{23-07-008}$  dated  $\underline{\text{July 24, 2023}}$  as indicated by my signature hereunder.

Bidder/Dealer	Print Name	Signature	Date	Tel. No.

# **CANVASSERS' CERTIFICATION**

We he	ereby certify that we have deliv	vered a copy of Canvass/Bid to be
opened on _	August 2, 2023 / 9:30am	_ to the above dealers or bidders.
_	(Date/Time)	_
CANV	ASSER	CANVASSER

**VARIOUS REPAIRS ROIX** 

PR No. 23-157 dated June 29, 2023

#### Republic of the Philippines Commission on Audit Cabatangan Hills, Zamboanga City –7000 Tel. No. 955-5883

PR No. 23-157 dated June 29, 2023 Name of the Procuring Entity PR No.: VARIOUS REPAIRS ROIX

Standard Form	Number:SF-Good-60

Revised on : May 24,2004	Date:	July 24, 2023
Standard form Title: Requested for Quotation	Quotation No. :	23-07-008

Company Name:	
Address:	

Please quote your lowest price on the item/s listed below, subject to the General Conditions on the last page, stating shortest time of delivery and submit your quotation duly signed by your representative not later than August 2, 2023, 9:30 AM  $\underline{\hspace{0.3cm}}$ \_In the return attached herewith or at this email address: bacsec.coaro9@gmail.com

- 1. ALL ENTRIES MAY BE TYPEWRITTEN OR HANDWRITTEN
- 2. WARRANTY SHALL BE FOR A PERIOD OF SIX (6) MONTHS FOR SUPPLIES & MATERIALS, ONE (1) YEAR FOR EQUIPMENT, FROM THE DATE OF ACCEPTANCE BY THE PROCURING ENTITY.
- 3. PRICE VALIDITY SHALL BE FOR THE PERIOD OF \_\_\_\_\_ CALENDAR DAYS
  4. PHILGEPS REGISTRATION CERTIFICATION/NUMBER & BUSINESS PERMIT SHALL BE ATTACHED UPON SUBMISSION OF THE QUOTATION
  5. DETAILED ESTIMATES SHALL BE ATTACHED UPON SUBMISSION OF THE QUOTATION
- 6. VALID PCAB LICENSE SHALL BE ATTACHED UPON SUBMISSION OF THE QUOTATION

ABC 107,498.96

		ABC		107,430.30	
No.	ITEM DESCRIPTION	QTY.	Unit	Unit Price	Total Amount
1	Construction of Drainage System and Installation of Gutter at Staff House				
I	Structure Excavation	6.05	cu.m		
II	Structural Concrete	0.84	cu.m		
Ш	Reinforcing Steel	133.33	kg		
IV	100mm CHB Non Load Bearing	13.44	sq.m		
v	Cement Plaster Finish	25.20	sq.m		
VI	Drainage Grates	1.00	lot		
VII	Gutter	1.00	lot		
	Contract Duration: 14 Calendar Days				
	Location: COA ROIX, Cabatangan, Zamboanga City				

**ABC** 88,806.34 No. ITEM DESCRIPTION Unit Total Amount QTY. **Unit Price** Fabrication & Installation of Steel Stairs I Scaffoldings 1.00 lot II Stairs 1.00 lot

Contract Duration: 10 Calendar Days Location: COA ROIX, Cabatangan, Zamboanga City

280.665.00 **ARC** 

		ADC		200,003.00	
No.	ITEM DESCRIPTION	QTY.	Unit	Unit Price	Total Amount
3	Conversion/Replacement of Fluorescent linear tube to T8 LED Tube				
	Labor:				
	Electritian	1	UNIT		
	Materials:				
	T8 Led Tube - 18 watts	240	pcs		
	T8 Led Tube Holder/Socket	480	pcs		
	LED bulb / Pin Light	40	pcs		
	Electrical Tape	5	pcs		
	THHN / THWN-2 Wire 3.5mm (150 mtrs)	2	pcs		
	Contract Duration: 30 Calendar Days				
	Location: COA ROIX, Cabatangan, Zamboanga City				

ABC 172,587.57

No.	ITEM DESCRIPTION	QTY.	Unit	Unit Price	Total Amount
4	REPAIR & REPAINT OF ELEVATED WATER TANK				
4	STRUCTURE				
I	Health and Safety	1.00	lot		
		1.00			
II	Surface Preparation	1.00	lot		
III	Welding Works	1.00	lot		
IV	Steel Painting	78.13	sq.m.		
	Contract Duration: 45 Calendar Days				
	Location: COA ROIX, Cabatangan, Zamboanga City				

ABC 135,496.25

No.	ITEM DESCRIPTION	QTY.	Unit	Unit Price	Total Amount
5	COA Canteen Extension				
I	Mobilization and Demobilization	1.00	L.S.		
II	Steel Works (Columns & Bracket Support)	1.00	L.S.		
Ш	Roof Framing (Fabrication/Installation)	1.00	L.S.		
IV	Roofing Works (Corrugated Polycarbonate)	25.00	sq.m		
v	Tiles Works	22.00	sq.m		
VI	Miscellaneous Works - Steel Railings	4.00	ln.m		
	Contract Duration: 28 Calendar Days				
	Location: COA ROIX, Cabatangan, Zamboanga City				


ABC 62,674.74

No.	ITEM DESCRIPTION	QTY.	Unit	Unit Price	Total Amount
6	REPAIR OF 3 SPANS OF COA RO 9 PERIMETER FENCE				
I	Cut (Tiktik) 0.20m width thru CHB wall to ftg perpendicularly adjacent to the column	1.00	l.s		
II	Lap splice by welding the CHB horizontal bars and vertical column bars/dowels	1.00	l.s		
III	Concrete works	0.30	cu.m.		
IV	Plastering works	46.80	sq.m.		
V	Painting works	67.60	sq.m.		
	Contract Duration: 17 Calendar Days				
	Location: COA ROIX, Cabatangan, Zamboanga City				


ABC 56,296.24

No.	ITEM DESCRIPTION	QTY.	Unit	Unit Price	Total Amount
7	Construction of Guard House at Training Center				
I	Concrete Works	1.25	cu.m		
II	Reinforcing Steel Bar	105.46	kgs		
III	Masonry Works	5.76	sq.m		
IV	Roofing Works	13.14	sq.m		
V	Carpentry Works	1.00	lot		
			•		
	Contract Duration: 25 Calendar Days				
	Location: COA ROIX, Cabatangan, Zamboanga City				

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# SITE DEVELOPMENT PLAN Scale: NTS

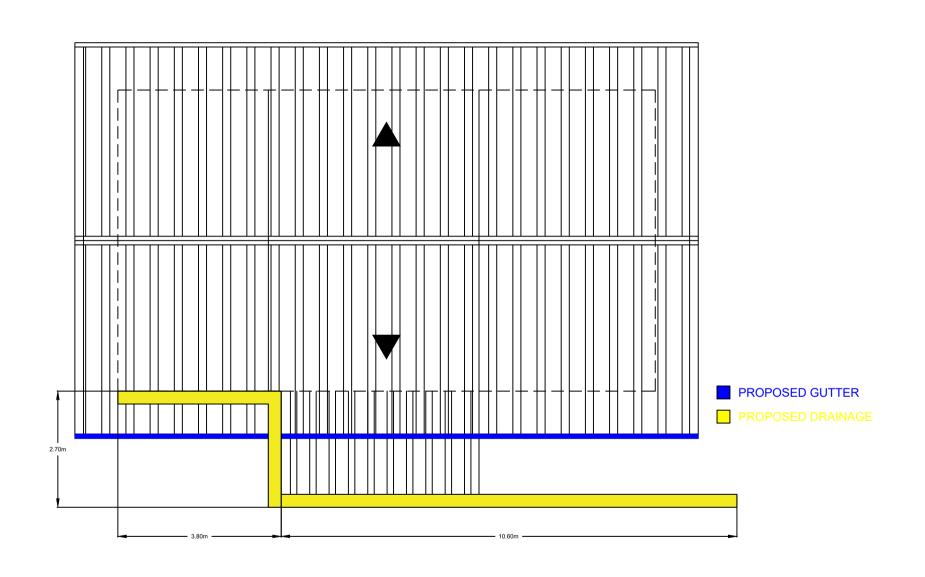

CONSTRUCTION OF DRAINAGE SYSTEM AND INSTALLATION OF GUTTER AT STAFF HOUSE COMMISSION ON AUDIT REGIONAL OFFICE - IX,

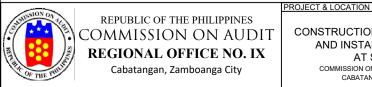CABATANGAN, ZAMBOANGA CITY

ROMMEL - KHAN A. JAMANULLA
TAS I

PREPARED BY:

CHARLES R. BULAC
Chief TAS
OIC - Supervising STAS


RECOMMENDING APPROVAL:


MARISOL D. LEGASPI OIC - Director IV Regional Director


APPROVED BY:

1/3

SHEET NO.

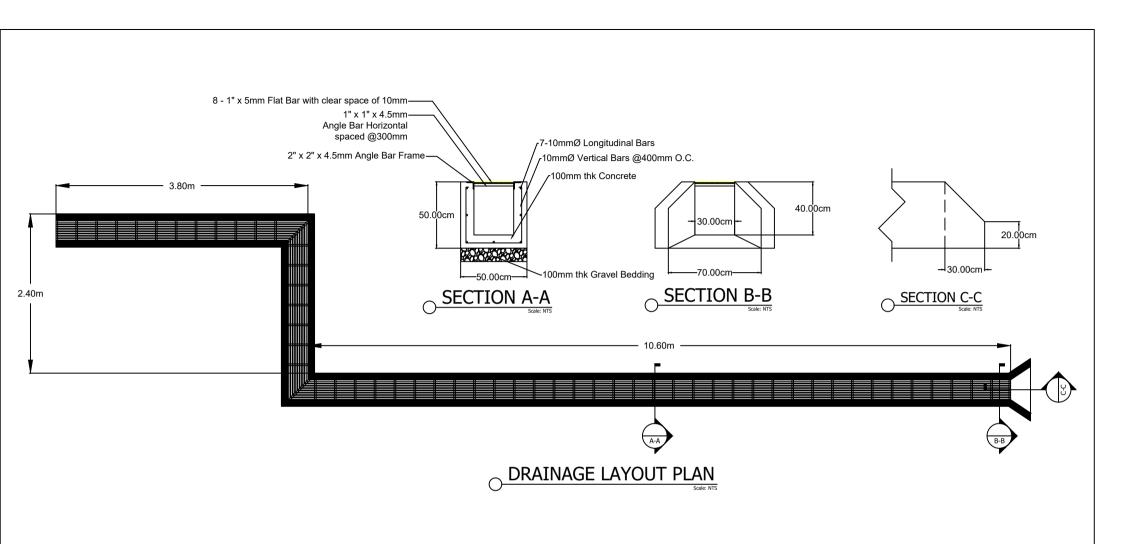

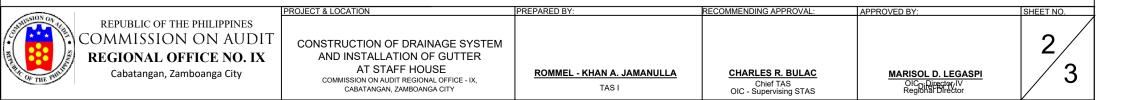

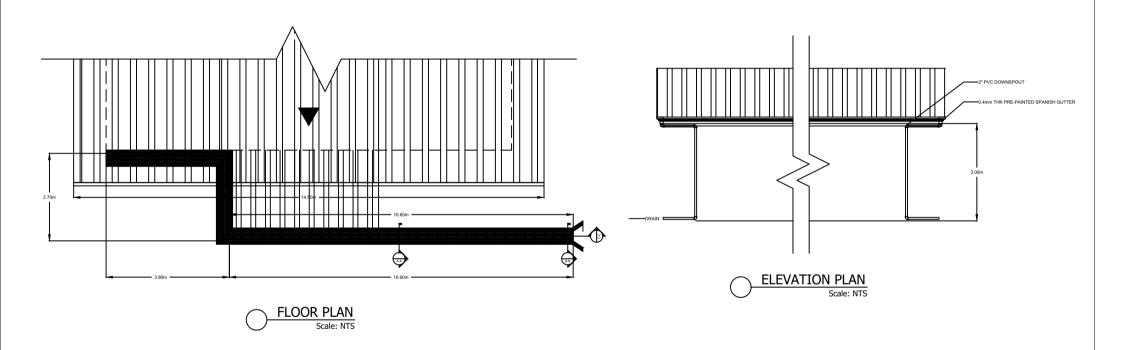



**ROMMEL - KHAN A. JAMANULLA** 

CHARLES R. BULAC Chief TAS OIC - Supervising STAS

RECOMMENDING APPROVAL:

MARISOL D. LEGASPI OIC - Director IV Regional Director

APPROVED BY:

SHEET NO.


Project Name: Construction of Drainage System and Installation of Gutter at Staff House Location: Commision on Audit Regional Office IX, Cabatangan, Zamboanga City


Duration: 14 C.D


#### Detailed Estimate

		10	** **	I II ' G . I	m . 1
L_	G	Quantity	Unit	Unit Cost	Total
I	Structure Excavation	6.05	cu.m		
	Materials				
	Labor Cost				
	Equipment Cost				
	Total Direct Cost				
	Total Indirect Cost				
	Total Cost				
II	Structural Concrete	0.84	cu.m		
	Materials	0.01	Cum		
	a. Gravel	1.00	cu.m.		
	b. Sand	1.00	cu.m.		
	c. Portland Cement	9.00	bags		
	For Gravel Bedding	7.00	oags		
	a. Gravel	1.00	cu.m.		
	a. Graver	1.00		laterial Cost	
	Labor Cost		I otal W	ateriai Cust	
-	Equipment Cost				
-	Total Direct Cost				
	Total Indirect Cost  Total Indirect Cost				
-	Total Cost  Total Cost				
-	Total Cust				
III	Reinforcing Steel	133.33	lr.o.		
111	Materials	133.33	kg		
	a. 36 - 10mm dia DSB	140.00	l. a		
	b. #16 Galvanized Iron Wire	2.00	kg kg		
	c. Consumables	2.00	Kg		
	c. Consumables		Total M	laterial Cost	
	Labor Cost		1 Otal W	lateriai Cost	
	Equipment Cost				
	Total Direct Cost				
	Total Indirect Cost  Total Indirect Cost				
	Total Cost				
	Total Cost				
	100mm CHB Non Load Bearing	13.44	sq.m		
	Materials	13.44	sq.m		
	a. 100mm thk CHB	175.00	рс		
	b. Cement	8.00	bags		
-	c. Sand	1.00	cu.m		
	c. Sand	1.00		laterial Cost	
	Labor Cost		I Gtai W	acciiai Cost	
	Equipment Cost				
	Total Direct Cost				
	Total Indirect Cost  Total Indirect Cost				
	Total Cost				
-	Total Cust				
IV	Cement Plaster Finish	25.20	sq.m		
<u> </u>	Materials	20.20	~4····		
	a. Cement	9.00	bags		
	b. Sand	1.00	cu.m		
		00		laterial Cost	
	Labor Cost				
	Equipment Cost				
	Total Direct Cost				
	Total Indirect Cost				
	Total Cost				
		•			

				T	I
V	Drainage Grates	1.00	lot		
_	Materials	1.00	101		
	a. 2"x2"x4.5mm AngleBar	6.00	lts		
	b. 1"x1"x4.5mm AngleBar	4.00	lts		
	c. Flat Bar 1"x5mm	25.00	lts		
	d. Welding rod 1/8"	1.00	box		
	e. Cutting Disc	5.00	pcs		
	f. Grinding Stone	2.00	pcs		
	,		1		
	a. epoxy Primer	1.00	gal		
	a.1. epoxy Reducer	1.00	L		
	b. Rubberrized Paint	1.00	gal		
	b.1 Reducer	1.00	L		
			Total M	<b>Iaterial Cost</b>	
	Labor Cost				
	Equipment Cost				
	Total Direct Cost				
	Total Indirect Cost				
	Total Cost				
VI	Gutter	1.00	lot		
	Materials				
	a. Gutter - 0.4mm thk x 2.44m Pre-painted Spanish Gutter	6.00	pc		
	b. Blind Rivets	50.00	pc		
	c. 57mm(2") x 3.0m S-1000 PVC Pipes	6.00	pc		
	d. 57mm(2") x 90degree PVC Elbow	6.00	pc		
	e. PVC Solvent	1.00	can		
	f. 10- 2"x2"x10' Coco Lumber	33.33	bd.ft		
	g. 3" CWN	1.00	kg		
	f. Consumables (3% of Materials Cost)				
			Total M	<u> Iaterial Cost</u>	
<u> </u>	Labor Cost				
<u> </u>	Equipment Cost				
<u> </u>	Total Direct Cost				
<u> </u>	Total Indirect Cost				
	Total Cost				

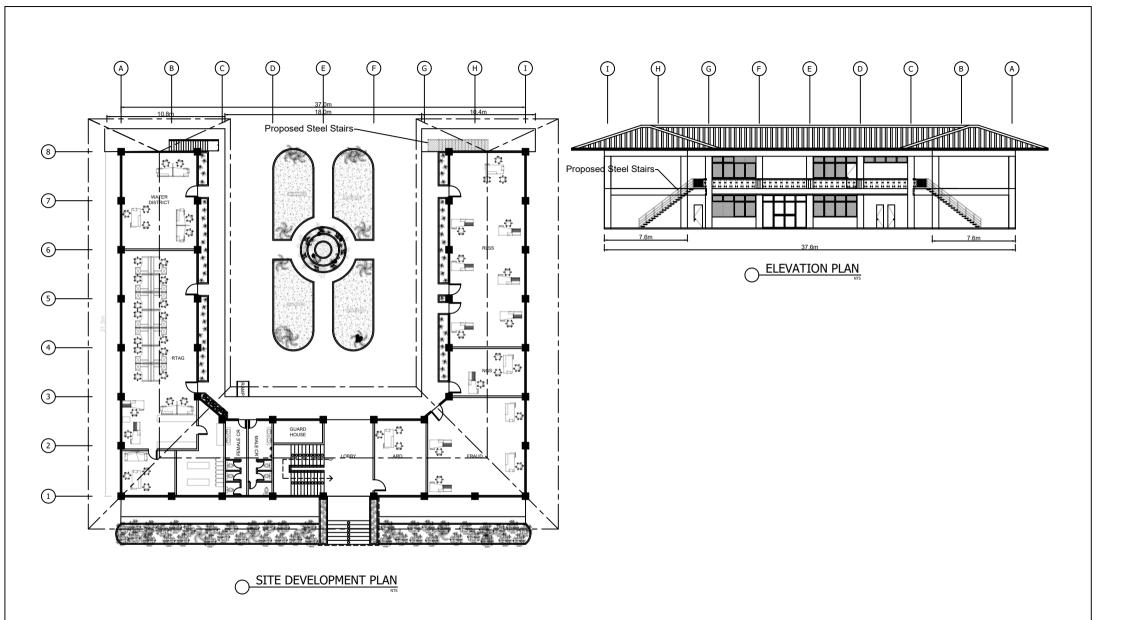

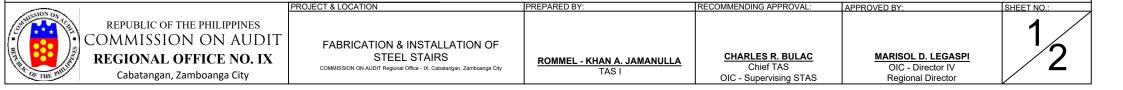

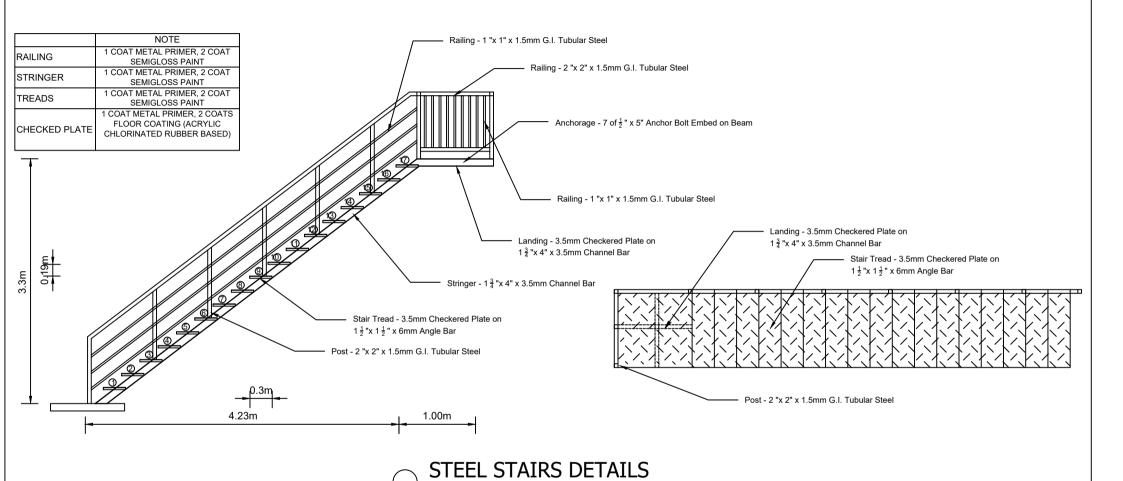



FABRICATION & INSTALLATION OF STEEL STAIRS
COMMISSION ON AUDIT Regional Office - IX, Cabatangan, Zamboanga City

ROMMEL - KHAN A. JAMANULLA TAS I

PREPARED BY:

CHARLES R. BULAC
Chief TAS
OIC - Supervising STAS

RECOMMENDING APPROVAL

MARISOL D. LEGASPI
OIC - Director IV
Regional Director

APPROVED BY:

2/2

SHEET NO .:

Project Name: Fabrication & Installation of Steel Stairs

Location: Commission on Audit Regional Office IX, Cabatangan, Zamboanga City

Duration: 10 Calendar Days

#### **Detailed Estimate**

		Quantity	Unit	Unit Cost	Total
I	Scaffoldings	1.00	lot		
	Scope of Work:				
	Painting Works, Installation of Stairs, and				
	Cladding of Concrete Canopy				
	Materials				
	a. 30 - 2"x3"x12' Coco Lumber	180.00	bd.ft		
	b. 4" CWN	3.00	kg		
	c. Consumables	-	-	-	
			Tota	l Material Cost	
	Labor Cost				
	Equipment Cost				
	Total Direct Cost			1	
	Total Indirect Cost			1	
	Total Cost			+ +	
				+	
II	Stairs	1.00	lot	+	
	Materials	1.00	101	+ +	
	a. Channel Bar 1 3/4" x 4" x 3.4mm	3.00	pcs	+	
	b. Angle Bar 1 1/2" x 1 1/2" x 1/4"	7.00	pcs	+	
	c. Tubular 2" x 2" x 1.5mm	3.00	pcs	+	
	d. Tubular 1" x 1" x 1.5mm	5.00	pcs	+ +	
	e. Checkered Plate 3.5mm x 4' x 8'	2.00	sht	+ +	
	f. Welding Rod	1.00	box	+ +	
	g. Cutting Disc	6.00	pcs	+ +	
	h. Epoxy Primer	1.00	gal	+	
	i. Epoxy Printer	1.00	L	+	
	j. Ruberized Paint	2.00	gal		
	k. Reducer	1.00	L	+	
	l. Anchor Bolt 1/2" x 5"	7.00	pcs	+	
	m. Consumables	7.00	pes	+	
	m. Consumations	_	Tota	l Material Cost	
	Labor Cost		1014	i Material Cost	
	Equipment Cost			+	
	a. Welding Machine	42.00	hr	+	
	b. Cut-off Wheel	14.00	hr	+	
	c. Grinding Wheel	14.00	hr	+	
	Minor Tools (10% of Labor)	14.00	111	+ +	
	Total Direct Cost	<del>                                     </del>		+	
	Total Indirect Cost  Total Indirect Cost			+ +	
	Total Indirect Cost  Total Cost			+ +	
	Total Cost			+	

GRAND TOTAL


#### **Project Name and Location**

Proposed Conversion / Replacement of Fluorescent linear tube to T8 Led Tube (COA Main Building)

DETAILED ESTIMATES							
Lighting Fixture	1.00	lot					
Labor	# of Domestic	# of Davis		Per Fixture rate	Amount		
	# of Persons	# of Days		Per Fixture rate	Amount		
Electritian	-	-					
Materials	# of Units	Unit	Unit Cost		Amount		
T8 Led Tube - 18 watts	240.00	pcs					
T8 Led Tube Holder/Socket	480.00	pcs					
LED bulb / Pin Light	40.00	pcs					
Electrical Tape	5.00	pcs					
THHN / THWN-2 Wire 3.5mm (150 mtrs)	2.00	pcs					
Direct Cost							
OCM (20%)							
VAT (5%)							
Total Cost							
Total Unit Cost							
			TOTAL				

#### Scope of Works:

- 1. Removal of existing flourescent tube including its ballast and starter.
- 2. Install new Socket/Holder for the T8 Led Tube, re-wire if needed on the connection.
- 3. Replace the bulbs in areas where there is no t8 led tube installed.

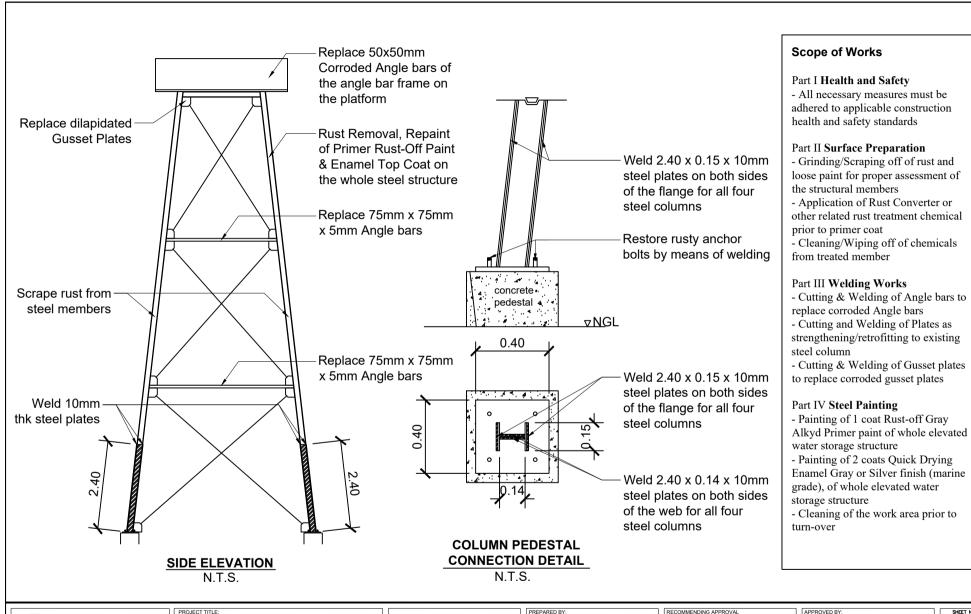



PROJECT TITLE:

REPAIR AND REPAINTING OF ELEVATED WATER TANK STRUCTURE AT COA RO IX

LOCATION: COA-IX. CABATANGAN, ZAMBOANGA CITY

SIDE ELEVATION DETAIL OF COLUMN PEDESTAL CONNECTION

PREPARED BY:

MARK ANTHONY M. FUNES STAA - II

**CHARLES R. BULAC** STAS III, OIC-SUPERVISING STAS APPROVED BY



#### Project & Location: Repair & Repaint of Elevated Water Tank Structure

at COA RO IX Cabatangan, ZC

#### **Scope of Works**

#### Part I Health and Safety

- All necessary measures must be adhered to applicable construction health and safety standards

#### Part II Surface Preparation

- Grinding/Scraping off of rust and loose paint for proper assessment of the structural members
- Application of Rust Converter or other related rust treatment chemical prior to primer coat
- Cleaning/Wiping off of chemicals from treated member

#### Part III Welding Works

- Cutting & Welding of Angle bars to replace corroded Angle bars
- Cutting and Welding of Plates as strengthening/retrofitting to existing steel column
- Cutting & Welding of Gusset plates to replace corroded gusset plates

#### Part IV Steel Painting

- Painting of 1 coat Rust-off Gray Alkyd Primer paint
- Painting of 2 coats Quick Drying Enamel Gray or Silver finish, paint must be marine grade
- Cleaning of the work area prior to turn-over

#### **Cost Estimates**

	Descripti	on Works t	o be done		Quantity	unit	unit cost	Total
Part I	Health and Safety							
	Equipment							
	1	Body Harne	ess		2.00	sets		
		Respirator 1	Mask		2.00	pcs		
		Protective (	Gloves		2.00	pairs		
		Scaffolds			1.00	lot		
Part II	Surface P	reparation						
	Equipment	:						
		Angle grind	ler		1.00	unit		
	Materials:							
		Rust Conve	erter		1.00	gal		
		Wire brush			2.00	pcs		
		Nylon brus	h		2.00	pcs		
		Putty Knife	/ Scraping	tool	2.00	pcs		
		Cloth rag			2.00	pcs		
		Asstd grit S	andpaper		1.00	lot		
Part III	Welding V	Vorks						
	Equipment					# of days	rental rate	
		Welding M	achine		1.00	5		
		Cutting out			1.00	3		
		Cut-off ma	chine		1.00	1		
	Materials:				Quantity	unit	unit cost	Total
		Oxy/Acetyl	ene		1.00	lot		
		Welding M	ask		1.00	pc		
		Welding G	loves		2.00	pairs		
		Welding Ro			1.00	box		
		75 x 75 x 5	mm angle l	oar	8.00	pcs		
		50 x 50 x 5			4.00	pcs		
		steel plate (			2.00	pcs		
		steel plate (	1.2m x 2.4	x 5mm)	1.00	pc		

Part IV	Steel Pain	ting						
	Equipment	t:						
		Paint Tray			2.00	pcs		
		Paint Rolle	rs		2.00	pcs		
		Paint Brush	1		2.00	pcs		
	Materials:							
		Paint Thin	ner		1.00	gal		
	(1 coat)	Rust-Off C	ray Alkyd ı	metal primei	3.50	gal		
	(2 coats)	Quick Dryi	ng Enamel	- Gray/Silve	7.00	gal		
	sub-total							-
	Labor (%)							
	Estimated	Direct Cost						-
	Indirect Co	ost (20% of	EDC)					-
	VAT (5%)							-
	<b>Total Cos</b>	t						-

Steel Works

Item No./Description : II
Unit of Measurement :
Output per hour : L.s 1.000

	Designation	No. of Person	No. of Hours	Hourly Rate	Amount
A.	Labor			· · · · · · · · · · · · · · · · · · ·	
	a. Construction Foreman b. Skilled Laborer c. Unskilled Laborer	1 1 2	12 12 12	87.10 62.86 48.44	1,045.20 754.32 1,162.56
	Sub - Total for A  Name and Capacity	No of Units	No. of Hours	Hourly Rate	2,962.08  Amount
		NO OI UIILS	No. of Hours	пошту касе	Amount
в.	Equipment  Minor Tools (10% of Labor)				296.21
	Sub - Total for B				296.21
C.	Total (A + B)		!		3,258.29
D.	Output per hour = 1. sq.m.				•
E.	Direct Unit Cost (C ÷ D)				3,258.29
	Name and Specification	Unit	Quantity	Unit Cost	Amount
F.	Materials  a. 50 mm Ø G.I. Pipe b.Welding Rod c. Consumables (3% of Materials Cost)	sq.m. kg	3.00 1.00	1,975.00 150.00	5,925.00 150.00 182.25
	Sub - Total for F				6,257.25
G. H.	` '		120/	of C	9,515.54
н.   І.	Contractor's Profit (CP)		12% 8%		1,141.86 761.24
	Value Added Tax (VAT)			of (G + H + I)	570.93
	Total Unit Cost			(G + H + I + J)	11,989.58

Item No./Description : III Roof Framing (Fabrication/Installation)
Unit of Measurement : L.s
Output per hour : 1.000

		ı			
	Designation	No. of Person	No. of Hours	Hourly Rate	Amount
A.	Labor				
	a. Construction Foreman	1	32	87.10	2,787.20
	b. Skilled Laborer	1 2	32	62.86	2,011.52
	c. Unskilled Laborer	2	32	48.44	3,100.16
	Sub - Total for A				7,898.88
	Name and Capacity	No of Units	No. of Hours	<b>Hourly Rate</b>	Amount
B.	Equipment				
	-4F				
	Minor Tools (10% of Labor)				789.89
	Sub - Total for B				789.89
C.	Total (A + B)				8,688.77
D.	Output per hour = 1. sq.m.				0,000
E.	Direct Unit Cost (C ÷ D)				8,688.77
	Name and Specification	Unit	Quantity	Unit Cost	Amount
F.	Materials				
	a. B.I. Tubular (100mm x 50mm x 1.5mm thk)	pcs	10.00	126.95	1,269.50
	B.I. Tubular (100mm x 50mm x 1.2mm thk)	pcs	5.00	1,528.35	7,641.75
	b.Welding Rod	kg	2.00	150.00	300.00
	c. Red Oxide Primer d. Enamel Paint	gal	1.00	575.00	575.00 700.00
	e. Paint thinner	gal L	1.00 1.00	700.00 245.00	245.00
	Consumables (3% of Materials Cost)	L L	1.00	243.00	321.94
	donsamables (5 % of Materials dose)				521.71
	Sub Total for E				11 052 10
C	Sub - Total for F Direct Unit Cost (E + F)				11,053.19 19,741.96
	Overhead, Contingencies & Miscellaneous (OCM)		12%	of G	2,369.03
I.	Contractor's Profit (CP)		8%		1,579.36
			- 70		
J.	Value Added Tax (VAT) Total Unit Cost		<u>5</u> %	of (G + H + I)	1,184.52

Roofing Works (Corrugated Polycarbonate)


Item No./Description : IV
Unit of Measurement :
Output per hour : sq.m. 2.769

	Designation	No. of Person	No. of Hours	Hourly Rate	Amount
A.	Labor				
	a. Construction Foreman	1	1	87.10	87.10
	b. Skilled Laborer	1	1	62.86	62.86
	c. Unskilled Laborer	2	1	48.44	96.88
	Sub - Total for A				246.84
	Name and Capacity	No of Units	No. of Hours	Hourly Rate	Amount
B.	Equipment				
	Minor Tools (10% of Labor)				24.68
	Sub - Total for B				24.68
C.	Total (A + B)	•			271.52
	Output per hour = 2.769 sq.m.				
Ε.					
	,	YIis	0	Harita Cornt	98.06
	Name and Specification	Unit	Quantity	Unit Cost	98.06 Amount
		Unit	Quantity	Unit Cost	
	Name and Specification  Materials		· ·		Amount
	Name and Specification  Materials  a. Corrugated Polycarbonate (3' X 8')	sq.m.	1.00	650.00	<b>Amount</b> 650.00
	Name and Specification  Materials  a. Corrugated Polycarbonate (3' X 8') b. Tek screw/J-bolt with washers		· ·		Amount
	Name and Specification  Materials  a. Corrugated Polycarbonate (3' X 8')	sq.m.	1.00	650.00	Amount 650.00 65.00
	Name and Specification  Materials  a. Corrugated Polycarbonate (3' X 8') b. Tek screw/J-bolt with washers	sq.m.	1.00	650.00	Amount 650.00 65.00
	Name and Specification  Materials  a. Corrugated Polycarbonate (3' X 8') b. Tek screw/J-bolt with washers	sq.m.	1.00	650.00	Amount 650.00 65.00
	Name and Specification  Materials  a. Corrugated Polycarbonate (3' X 8') b. Tek screw/J-bolt with washers	sq.m.	1.00	650.00	Amount 650.00 65.00
	Name and Specification  Materials  a. Corrugated Polycarbonate (3' X 8') b. Tek screw/J-bolt with washers	sq.m.	1.00	650.00	Amount 650.00 65.00
	Name and Specification  Materials  a. Corrugated Polycarbonate (3' X 8') b. Tek screw/J-bolt with washers	sq.m.	1.00	650.00	Amount 650.00 65.00
	Name and Specification  Materials  a. Corrugated Polycarbonate (3' X 8') b. Tek screw/J-bolt with washers	sq.m.	1.00	650.00	Amount 650.00 65.00
	Name and Specification  Materials  a. Corrugated Polycarbonate (3' X 8') b. Tek screw/J-bolt with washers	sq.m.	1.00	650.00	Amount 650.00 65.00
	Materials  a. Corrugated Polycarbonate (3' X 8') b. Tek screw/J-bolt with washers c. Consumables (3% of Materials Cost)	sq.m.	1.00	650.00	650.00 65.00 21.45
F.	Name and Specification  Materials  a. Corrugated Polycarbonate (3' X 8') b. Tek screw/J-bolt with washers c. Consumables (3% of Materials Cost)  Sub - Total for F	sq.m.	1.00	650.00	Amount  650.00 65.00 21.45
F.	Name and Specification  Materials  a. Corrugated Polycarbonate (3' X 8') b. Tek screw/J-bolt with washers c. Consumables (3% of Materials Cost)  Sub - Total for F  Direct Unit Cost (E + F)	sq.m.	1.00 10.00	650.00 6.50	Amount  650.00 65.00 21.45  736.45 834.51
F. G. H.	Name and Specification  Materials  a. Corrugated Polycarbonate (3' X 8') b. Tek screw/J-bolt with washers c. Consumables (3% of Materials Cost)  Sub - Total for F  Direct Unit Cost (E + F)  Overhead, Contingencies & Miscellaneous (OCM)	sq.m.	1.00 10.00	650.00 6.50	736.45 834.51 100.14
G. H. I.	Name and Specification  Materials  a. Corrugated Polycarbonate (3' X 8') b. Tek screw/J-bolt with washers c. Consumables (3% of Materials Cost)  Sub - Total for F  Direct Unit Cost (E + F)	sq.m.	1.00 10.00	650.00 6.50	Amount  650.00 65.00 21.45  736.45 834.51

Item No./Description : V Tile Works

Item No./Description:VTile VUnit of Measurement:sq.m.Output per hour:1.95

	Designation	No. of Person	No of Hours	Hourly Rate	Amount
		Nor of Ferson	Noi of Hours	Trouris race	- Innount
A.	Labor				
	a. Construction Foreman	1	1	87.10	87.10
	b. Skilled Laborer	5	1	62.86	314.30
	c. Unskilled Laborer	5	1	48.44	242.20
	C. Oliskilieu Laborei	3	1	40.44	242.20
	Sub - Total for A				643.60
	Name and Capacity	No of Units	No. of Hours	Hourly Rate	Amount
B.	Equipment				
	Minor Tools (10% of Labor)				64.36
	Sub - Total for B				64.36
C.	Total (A + B)		I.		707.96
D.	Output per hour = 1.95 sq.m.				
E.	Direct Unit Cost (C ÷ D)				363.06
	N	TT 24	Quantity	Unit Cost	Amount
	Name and Specification	Unit	Quarter		Amount
F.	Materials	Unit	quantity		Amount
F.	Materials		· ·		
F.	Materials  a. Unglazed Tiles	sq.m.	1.050	1,500.00	1,575.00
F.	Materials  a. Unglazed Tiles b. Cement	sq.m. bags	1.050 0.325	1,500.00 280.00	1,575.00 91.00
F.	Materials  a. Unglazed Tiles b. Cement c. Sand	sq.m. bags cu.m.	1.050 0.325 0.026	1,500.00 280.00 950.00	1,575.00 91.00 24.70
F.	Materials  a. Unglazed Tiles b. Cement c. Sand d. Tile Grout	sq.m. bags cu.m. bags	1.050 0.325 0.026 0.125	1,500.00 280.00 950.00 110.00	1,575.00 91.00 24.70 13.75
	Materials  a. Unglazed Tiles b. Cement c. Sand d. Tile Grout e. Tile Adhesive	sq.m. bags cu.m.	1.050 0.325 0.026	1,500.00 280.00 950.00	1,575.00 91.00 24.70 13.75 53.63
	Materials  a. Unglazed Tiles b. Cement c. Sand d. Tile Grout	sq.m. bags cu.m. bags	1.050 0.325 0.026 0.125	1,500.00 280.00 950.00 110.00	1,575.00 91.00 24.70 13.75
	Materials  a. Unglazed Tiles b. Cement c. Sand d. Tile Grout e. Tile Adhesive	sq.m. bags cu.m. bags	1.050 0.325 0.026 0.125	1,500.00 280.00 950.00 110.00	1,575.00 91.00 24.70 13.75 53.63
	Materials  a. Unglazed Tiles b. Cement c. Sand d. Tile Grout e. Tile Adhesive	sq.m. bags cu.m. bags	1.050 0.325 0.026 0.125	1,500.00 280.00 950.00 110.00	1,575.00 91.00 24.70 13.75 53.63
	Materials  a. Unglazed Tiles b. Cement c. Sand d. Tile Grout e. Tile Adhesive	sq.m. bags cu.m. bags	1.050 0.325 0.026 0.125	1,500.00 280.00 950.00 110.00	1,575.00 91.00 24.70 13.75 53.63
	Materials  a. Unglazed Tiles b. Cement c. Sand d. Tile Grout e. Tile Adhesive	sq.m. bags cu.m. bags	1.050 0.325 0.026 0.125	1,500.00 280.00 950.00 110.00	1,575.00 91.00 24.70 13.75 53.63
	Materials  a. Unglazed Tiles b. Cement c. Sand d. Tile Grout e. Tile Adhesive	sq.m. bags cu.m. bags	1.050 0.325 0.026 0.125	1,500.00 280.00 950.00 110.00	1,575.00 91.00 24.70 13.75 53.63
	Materials  a. Unglazed Tiles b. Cement c. Sand d. Tile Grout e. Tile Adhesive f. Consumables (3% of Materials Cost)	sq.m. bags cu.m. bags	1.050 0.325 0.026 0.125	1,500.00 280.00 950.00 110.00	1,575.00 91.00 24.70 13.75 53.63 52.74
	Materials  a. Unglazed Tiles b. Cement c. Sand d. Tile Grout e. Tile Adhesive f. Consumables (3% of Materials Cost)	sq.m. bags cu.m. bags	1.050 0.325 0.026 0.125	1,500.00 280.00 950.00 110.00	1,575.00 91.00 24.70 13.75 53.63 52.74
G.	Materials  a. Unglazed Tiles b. Cement c. Sand d. Tile Grout e. Tile Adhesive f. Consumables (3% of Materials Cost)  Sub - Total for F  Direct Unit Cost (E + F)	sq.m. bags cu.m. bags	1.050 0.325 0.026 0.125 0.143	1,500.00 280.00 950.00 110.00 375.00	1,575.00 91.00 24.70 13.75 53.63 52.74
G. H.	Materials  a. Unglazed Tiles b. Cement c. Sand d. Tile Grout e. Tile Adhesive f. Consumables (3% of Materials Cost)  Sub - Total for F  Direct Unit Cost (E + F)  Overhead, Contingencies & Miscellaneous (OCM)	sq.m. bags cu.m. bags	1.050 0.325 0.026 0.125 0.143	1,500.00 280.00 950.00 110.00 375.00	1,575.00 91.00 24.70 13.75 53.63 52.74 1,810.82 2,173.87 260.86
G.	Materials  a. Unglazed Tiles b. Cement c. Sand d. Tile Grout e. Tile Adhesive f. Consumables (3% of Materials Cost)  Sub - Total for F  Direct Unit Cost (E + F)	sq.m. bags cu.m. bags	1.050 0.325 0.026 0.125 0.143	1,500.00 280.00 950.00 110.00 375.00	1,575.00 91.00 24.70 13.75 53.63 52.74

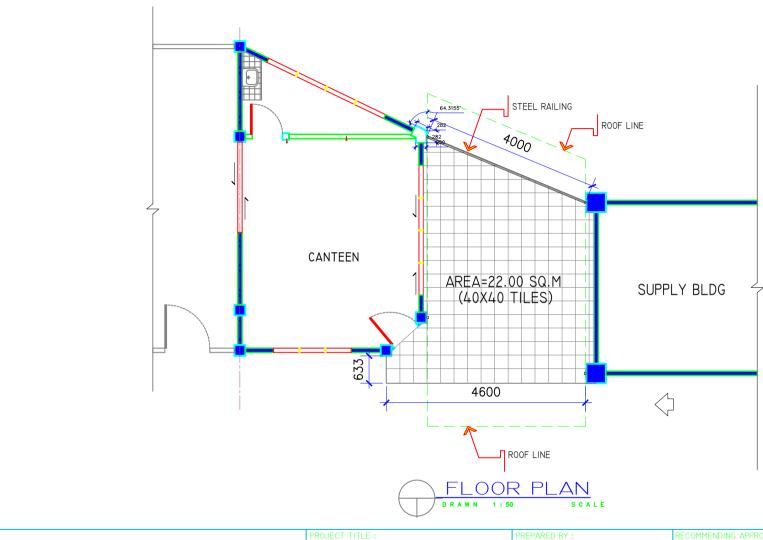



REPUBLIC OF THE PHILIPPINES **COMMISSION ON AUDIT** REGIONAL OFFICE NO. IX Cabatangan, Zamboanga City

PROPOSED EXTENSION OF COA CANTEEN

ANGELITO R. RICAFORTE

RECOMMENDING APPROVAL:

CHARLES R. BULAC


APPROVED BY:


MARISOL D. LEGASPI

OIC-DIRECTOR IV / REGIONAL DIRECTOR



SHEET NO.

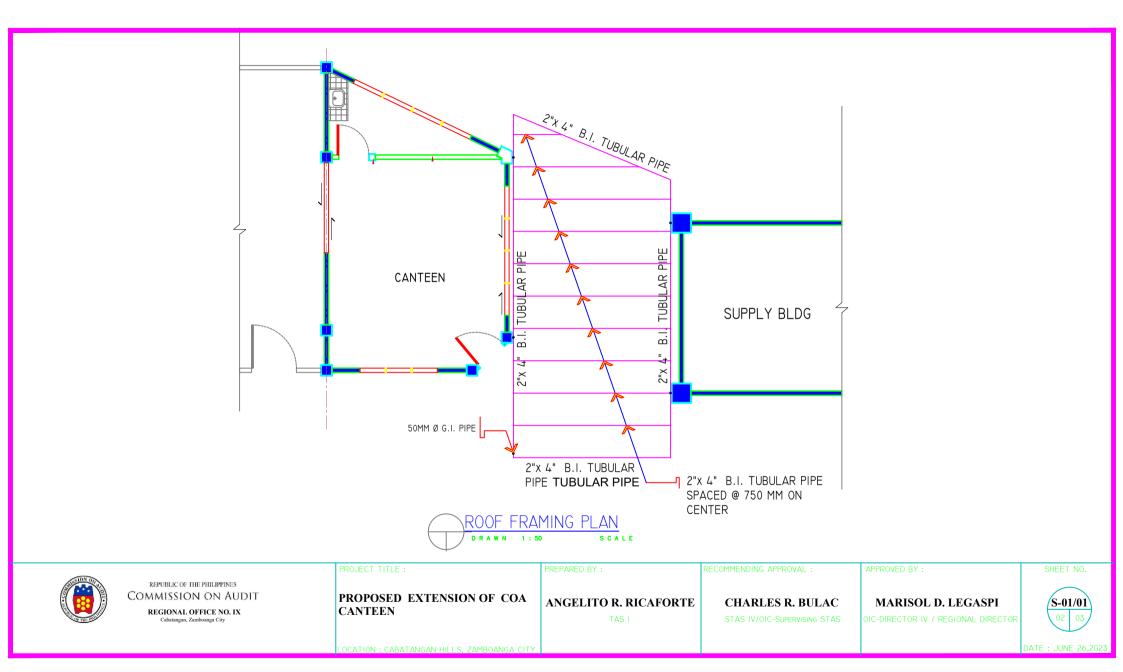

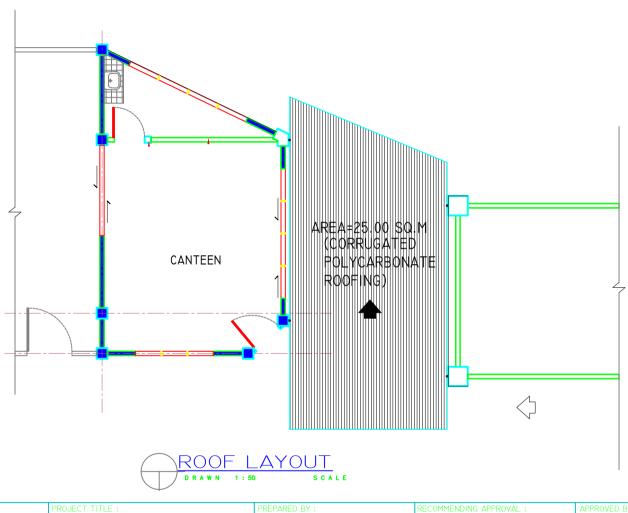



REPUBLIC OF THE PHILIPPINES COMMISSION ON AUDIT REGIONAL OFFICE NO. IX Cabatangan, Zamboanga City

PROJECT TITLE :

RECOMMENDING APPROVAL:

APPROVED BY:

SHEET NO.

PROPOSED EXTENSION OF COA CANTEEN

ANGELITO R. RICAFORTE

CHARLES R. BULAC

MARISOL D. LEGASPI

A-02/02

Title of the Project Repair of 3 spans of COA Fence

Location COA Regional Office 9, Cabatangan, Zamboanga City

Scope of work:

#### Span 1 & 2 refer to plans Fig. 1 & 2

- 1. Clearing the site where the repair works are to be done.
- Cut (tiktik) at about 0.20m width thru from top to CHB ftg. to locate CHB longitudinal bars and at column for vertical bars/dowels. Verify if the column dowels were rigidly connected to the columns.
- 3. Repair by splicing 10mm L shape lap welded for every 3 layers of horizontal bars to vertical t or column dowels.
- 4. Install forms on the affected portion then pour pure concrete.
- 5. Repair the existing cracks with concrete putty.
- 6. Re-plaster the entire spans front & back.
- 7. Re-paint the span 1/Figure 1 near the logo of COA (front & back)

#### Span 3 refer to plan Fig. 3

- 1. Remove damage portion at span 3 of the fence were the plaster was peeled off at ht = 1.00m and width=3.00m.
- 2. Repair exsting cracks.
- 3. Re-plaster the entire span front & back.

#### CHB wall (Fig 4 & 5)

- 1. Properly clean the wall surfaces and columns with sand paper in preparation for the application
- 2. Apply primer.
- 3. Apply bontide and patching comound on the cracks for even surface.
- 3. Apply 1st coating of liquid gloss with the desired color of the wall (refer to fig 4&5).
- 4. Apply the second coating with liquid tile gloss. Retached, if any.

#### Repainting of COA logo and name (Fig. 4)

- 1. Properly clean the COA logo, to remove the oil, stain and dust.
- 2. Apply primer.
- 3. Repaint liquid tile gloss the COA logo by using spray gun be sure that the new paint will stick
- 4. The new color should be same with the original color.
- 5. Levelling the uneven ground in front the COA Logo covering the 3 spans of the fence.





FIG. 1 FIG. 2

FIG. 1 & 2, SHOWS TWO SEPARATE SPAN OF PERIMETER FENCE WITH CHB WALL CRACKED & DETACHED FROM THE COLUMN.

SEE DETAIL ON SHEET 2 FOR THE PROPOSED REPAIR AND SPLICING. THEN PLASTER SMOOTH FIN. THE AFFECTED WALL & COLUMN. APPLY CONC. PUTTY TO WALL CRACKS. REPAINT FIG. 1 FRONT & BACK NEAR COA LOGO.



FIG. 3

FIG. 3, REMOVED DAMAGED PLASTER & REPLASTER WITH 3 M WIDTH & 1 M HEIGHT. APPLY CONCRETE PUTTY TO WALL CRACKS.

PROJECT TITLE:

Repair of 3 spans of COA fence

Location:

COA Regional Office 9
Cabatangan, Zamboanga City


PREPARED BY:

PAMELA J. TADEA STAS III RECOMMENDING APPROVAL

CHARLES R. BULAC OIC - Supervising STAS APPROVED BY:

MARISOL D. LEGASPI OIC DIRECTOR IV REGIONAL DIRECTOR SHEET NO.

1/3

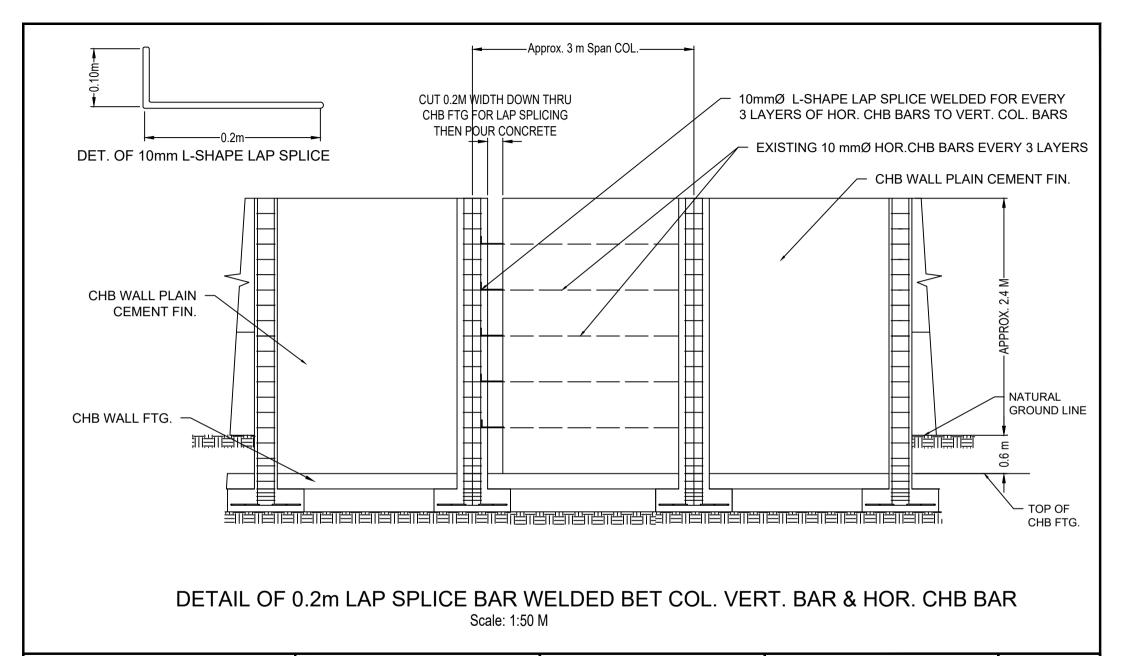

Repair of 3 spans of COA fence

Location:
COA Regional Office 9
Cabatangan, Zamboanga City

PREPARED BY:

PAMELA J. TADEA STAS III RECOMMENDING APPROVAL

CHARLES R. BULAC OIC - Supervising STAS

APPROVED BY:

MARISOL D. LEGASPI OIC DIRECTOR IV REGIONAL DIRECTOR SHEET NO.

 $\frac{2}{3}$ 





FIG. 4
FIG. 4, TO BE REPAIRED/REPAINTED THREE SPANS OF WALL
FENCE INCLUDING AGENCY NAME & LOGO.

FIG. 5
BACK OF THREE SPANS WALL FENCE

PROJECT TITLE:

Repair of 3 spans of COA fence

Location:

COA Regional Office 9 Cabatangan, Zamboanga City PREPARED BY:

PAMELA J. TADEA STAS III **RECOMMENDING APPROVAL** 

CHARLES R. BULAC OIC - Supervising STAS APPROVED BY:

MARISOL D. LEGASPI OIC DIRECTOR IV REGIONAL DIRECTOR SHEET NO.

3/3

#### **DETAILED ESTIMATES**

Construction of Guard House at Training Center **PROJECT:** COA RO No.IX, Cabatangan Hills, Zamboanga City LOCATION:

Concrete Works	1.25	cu.m		
ITEM	QTY	UoM	Unit Cost	Amount
Materials:				
Portland Cement	13.00	bags		
Washed Sand	1.00	cu.m		
Washed Gravel	2.00	cu.m		
Gravel Bedding	1.00	cu.m		
1/4" Ordinary Plywood	1.00	pc		
Coco Lumber	45.00	bd-ft		
Assorted CWN	3.00	kgs		
Soil Poisoning	5.76	sq.m		
Labor:				
Excavation Works				
Placing of Gravel Bedding				
Fabrication & Installation of Formworks				
Concreting of structural members				
			Material Cost	
			Lahan Cast	

Labor Cost

B	Reinforcing Steel Bars	105.46	kgs		
	ITEM	QTY	UoM	<b>Unit Cost</b>	Amount
	Materials:				
	12mm diameter x 6m	8.00	pcs		
	10mm diameter x 6m	17.00	pcs		
	#16 GI Tie Wire	3.00	kgs		
	Labor:				
	Cutting and Bending of Deformed Steel Bars				
	Installation of Deformed Steel Bars w/ Tie Wire				
				Material Cost	
				Labor Cost	

Masonry Works	5.76	sq.m		
ITEM	QTY	UoM	<b>Unit Cost</b>	Amount
Materials:				
4" CHB	75.00	pcs		
Portland Cement	5.00	bags		
Washed Sand	0.50	cu.m		
10mm diameter x 6m	4.00	pcs		
Labor:				
Installation of CHB				

Plastering of exposed Masonry Wall

Material Cost Labor Cost

#### **DETAILED ESTIMATES**

**PROJECT:** Construction of Guard House at Training Center COA RO No.IX, Cabatangan Hills, Zamboanga City **LOCATION:** 

Roofing Works	13.14	sq.m		
ITEM	QTY	UoM	<b>Unit Cost</b>	Amount
Materials:				
0.40mm thick Pre-painted Tilespan GI Roofing				
Sheet (Salvage Material)	14.40	ln.m		
1-1/2" Umbrella Nail	1.00	kg		
Roofing Sealant	1.00	ltr		
Refelctive Insulation	12.96	sq.m		
Labor:				
Cutting of Tilespan GI Roofing Sheet				
Installation of Tilespan GI Roofing Sheet				
Installation of Reflective Insulation				
			Material Cost	
			I alson Coot	

Labor Cost

E Carpentry Works	1.00	lot		
ITEM	QTY	UoM	<b>Unit Cost</b>	Amount
1/2" Marine Plywood	4.00	pcs		
2" x 4" Good Lumber (Salvage Material)	90.67	bd-ft		
2" x 2" Good Lumber	80.00	bd-ft		
Assorted CWN	2.00	kgs		
Double Action Spring Hinges	1.00	pair		
I aham		-		

#### Labor:

Cutting & Planer of Lumber for Post, Rafter and Girt (Salvage Material)

Installation of Horizontal and Vertical Studs

Installation of Marine Plywood

Fabrication of Flush Door

Material Cost Labor Cost

Project Name: Construction of Guard House at Training Center Project Location: COA RO No. IX, Cabatangan, Zamboanga City

# BILL OF QUANTITIES

Item	Description	Quantity	Units	
A	Concrete Works	1.25	cu.m	
В	Reinforcing Steel Bar	105.46	kgs	
С	Masonry Works	5.76	sq.m	
D	Roofing Works	13.14	sq.m	
Е	Carpentry Works	1.00	lot	



#### SCOPE OF WORK & SPECIFICATIONS

Project Name: Construction of Guard House at Training Center Project Location: COA RO No. IX, Cabatangan, Zamboanga City

Project Duration: 25 Calendar Days

#### Item A – Concrete Works

- 1. Concreting of slab on fill, footing, wall footing and pedestal.
- 2. Installation and removal of 1/4" ordinary plywood with coco lumber for all necessary formworks.
- 3. Supply and application of soil poisoning for the entire buildable area.
- 4. 100mm thick gravel bedding of the entire buildable area.

#### Item B – Reinforcing Steel Bars

- 1. Fabrication and installation of deformed steel bars for slab on fill, footing, wall footing and pedestal.
- 2. Use gauge number 16 galvanized iron tie wire.

### Item C – Masonry Works


- 1. Provide 0.60m high (from top of wall footing) 4" CHB with 10mm diameter deformed steel bar spaced every two layers horizontally and at 0.60m vertically.
- 2. Plastering of 12mm thick on all exposed masonry wall and pedestal.

#### Item D – Roofing Works

- 1. Roofing sheet to be supplied by COA-IX.
- 2. Cutting and installation of Tilespan roofing sheet.
- 3. Provide 10mm thick double-sided foam insulator on the entire roofing area.

## Item E – Carpentry Works

- 1. Cutting and planer of lumber for Post and Rafter (to be provided by COA-IX).
- 2. Installation of 2" x 2" good lumber as Purlins.
- 3. Provide 2" x 2" good lumber for horizontal frame and vertical studs spaced at 0.60m O.C.
- 4. Use ½ marine plywood as sidings for single walling.
- 5. Fabricate 0.60m x 1.00m flush type swing door with two sets of double action spring hinges.

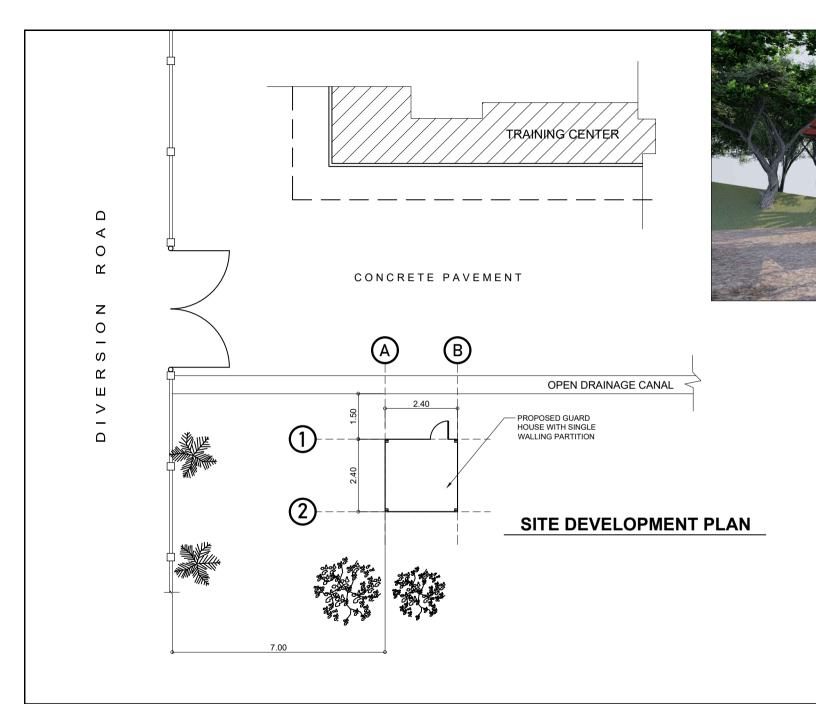



REPUBLIC OF THE PHILIPPINES
COMMISSION ON AUDIT
REGIONAL TECHNICAL AUDIT GROUP
REGIONAL OFFICE NO. IX
CABATANGAN HILLS, ZAMBOANGA CITY

PROJECT TITLE:

CONSTRUCTION OF GUARD HOUSE AT TRAINING CENTER

LOCATION: COA RO No.IX, CABATANGAN, ZAMBOANGA CITY

PREPARED BY:


RONAMARIE E. ESTEBAN STAS I RECOMMENDING APPROVAL:


CHARLES R. BULAC


STAS IV/OIC-SUPERVISING STAS


APPROVED BY:



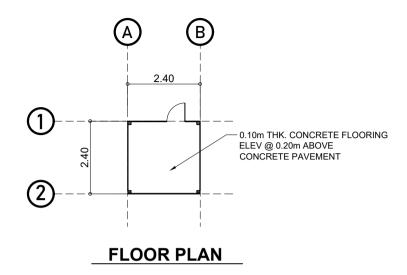

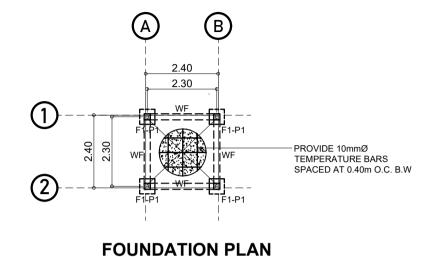

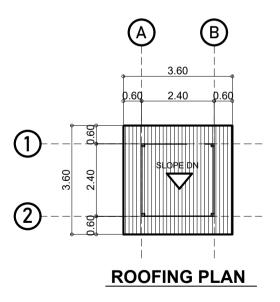

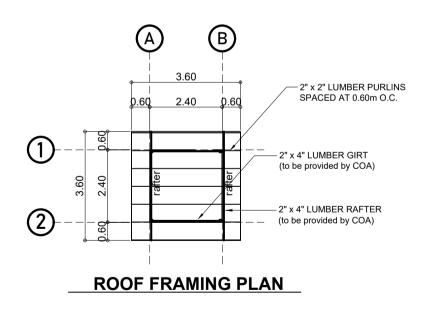

REPUBLIC OF THE PHILIPPINES
COMMISSION ON AUDIT
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REGIONAL OFFICE NO. IX
CABATANGAN HILLS, ZAMBOANGA CITY

PROJECT TITLE:

CONSTRUCTION OF GUARD HOUSE AT TRAINING CENTER

LOCATION: COA RO No.IX, CABATANGAN, ZAMBOANGA CITY


PREPARED BY:

RONAMARIE E. ESTEBAN STAS I RECOMMENDING APPROVAL:

CHARLES R. BULAC
STAS IV/OIC-SUPERVISING STAS

APPROVED BY:



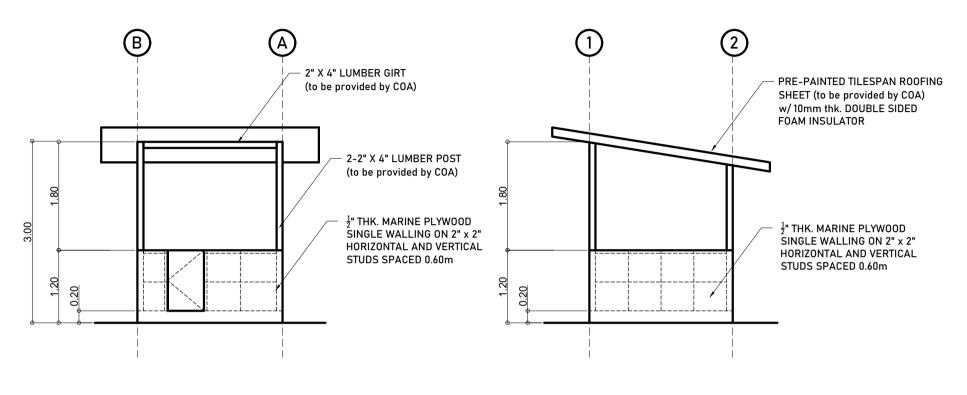

FRONT ELEVATION

**RIGHT SIDE ELEVATION** 



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CABATANGAN HILLS, ZAMBOANGA CITY

PROJECT TITLE:

CONSTRUCTION OF GUARD HOUSE AT TRAINING CENTER

LOCATION: COA RO No.IX, CABATANGAN, ZAMBOANGA CITY


PREPARED BY:

RONAMARIE E. ESTEBAN STAS I RECOMMENDING APPROVAL:

CHARLES R. BULAC
STAS IV/OIC-SUPERVISING STAS

APPROVED BY:



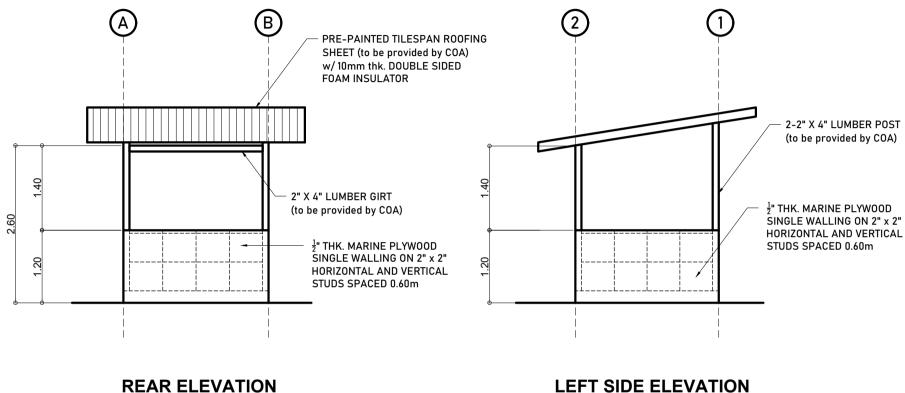

**LEFT SIDE ELEVATION** 



REPUBLIC OF THE PHILIPPINES COMMISSION ON AUDIT REGIONAL TECHNICAL AUDIT GROUP
REGIONAL OFFICE NO. IX CABATANGAN HILLS, ZAMBOANGA CITY

PROJECT TITLE:

CONSTRUCTION OF GUARD HOUSE AT TRAINING CENTER

LOCATION: COA RO No.IX, CABATANGAN, ZAMBOANGA CITY


PREPARED BY:

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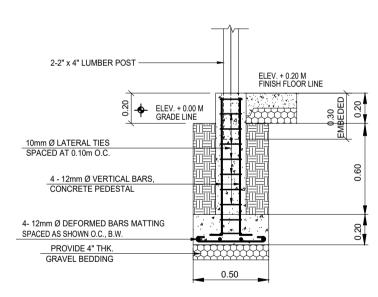
RECOMMENDING APPROVAL:

CHARLES R. BULAC STAS IV/OIC-SUPERVISING STAS APPROVED BY:



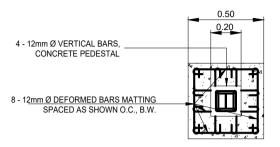

FOOTING PLAN



FOOTING SECTION

