

ALL PLUMBING WORKS INCLUDED HEREIN SHALL BE EXECUTED ACCORDING TO THE REQUIREMENTS OF THE UNIFORM PLUMBING CODE OF THE PHILIPPINES AND THE RULES AND REGULATIONS OF THE GOVERNMENT. NOTHING CONTAINED ON THE DRAWING SHALL BE CONSTRUCTED AS TO CONFLICT WITH THE NATIONAL AND LOCAL ORDINANCES OR LAWS GOVERNING THE IMPLEMENTATION OF THE PLUMBING WORKS.

REFER TO ALL ELECTRICAL, STRUCTURAL, AND ARCHITECTURAL PLANS AND SPECIFICATIONS AND INVESTIGATE ALL POSSIBLE INTERFERENCES AND CONDITIONS AFFECTING PLUMBING WORKS.

THE ENGINEER AND ARCHITECT SHALL BE IMMEDIATELY NOTIFIED FOR ANY DISCREPANCY FOUND THEREIN.

PIPES SHALL BE WITH PRIOR APPROVAL OF THE ARCHITECT AND ENGINEER.

PROPOSED SANITARY UTILITIES SHALL CONFORM WITH THE ACTUAL LOCATION, DEPTH, AND INVERT ELEVATION OF ALL EXISTING PIPES STRUCTURE.

ALL SLOPES FOR HORIZONTAL BRANCHES SHALL MAINTAIN 1% AS MINIMUM UNLESS STATED OTHERWISE.

ALL SEWER LINES SHALL BE UPVC PIPE SERIES 1000 BY EMERALD OR EQUIVALENT.

ALL VENT PIPES SHALL BE UPVC PIPE SERIES

ALL DOWNSPOUTS SHALL BE PVC PIPE SERIES 1000.

ALL COLD WATER LINES SHALL BE PPR PN-20 TYPE THERMOVAR OR FOLIVIENT

LEGENDS & SYMBOLS

WATER SUPPLY DISTRIBUTION SYSTEM

COLD WATERLINE ——— GV **GATE VALVE** —N cv CHECK VALVE - F/SHO FAUCET & SHOWER 0 RISER

WASTEWATER COLLECTION SYSTEM

SP SOIL PIPE VP VENT PIPE VENT PIPE ABOVE CEILING VPTW AC VENT THRU WALL ABOVE CL VENT STACK ABOVE CL. CO **CLEAN OUT** FLOOR DRAIN ___

0 PIPE STACK 0 WATER CLOSET

URI URINAL DP DRAIN PIPE

RD

DOWNSPOUT CB

0) E

ROOF DRAIN

APPROVED:

CATCH BASIN



REPUBLIC OF THE PHILIPPINES COMMISSION ON AUDIT REGIONAL OFFICE NO. IX

PROJECT & LOCATION:

CABATANGAN, ZAMBOANGA CITY

RECOMMENDING APPROVAL:

VISITACION Q. MENDOZA
DIRECTOR IV - REGIONAL DIRECTOR

PREPARED

AMELIA P. VALDEZ
DIRECTOR IV - GENERAL SERVICES OFFICE

LORNA D. CABOCHAN

REPUBLIC OF THE PHILIPPINES DEPARTMENT OF PUBLIC WORKS AND HIGHWAYS REGIONAL OFFICE IX VETERANS EXTENSION AVE., TETUAN, ZAMBOANGA CITY

COA REGIONAL OFFICE NO. IX TRAINING CENTER AND DORMITORY BUILDING

CABATANGAN, ZAMBOANGA CITY

SHEET CONTENT: SECOND FLOOR WATER LINE LAYOUT GENERAL NOTES LEGENDS AND SYMBOLS

PIO MARIO T LACASTESANTOS AR-RAFIA. SALUAN REGISTERED SANITARY ENGINEER CHIEF, BRIDGE & OTHER PUBLIC WORKS DESIGN SECTION

REVIEWED:

SATURNINO C. TORREFRANCA DISTRICT ENGINEER OIC - CHIEF, PLANNING & DESIGN DIVISION


SUBMITTED:

KHADAFFY D. TANGGOL

RECOMMENDED


APPROVED (BY THE AUTORITY OF THE CHAIRPERSON)

CAYAMOMBAO D. DIA, CESO IV

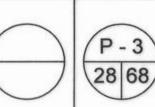

SHEET NO .:

SET NO.

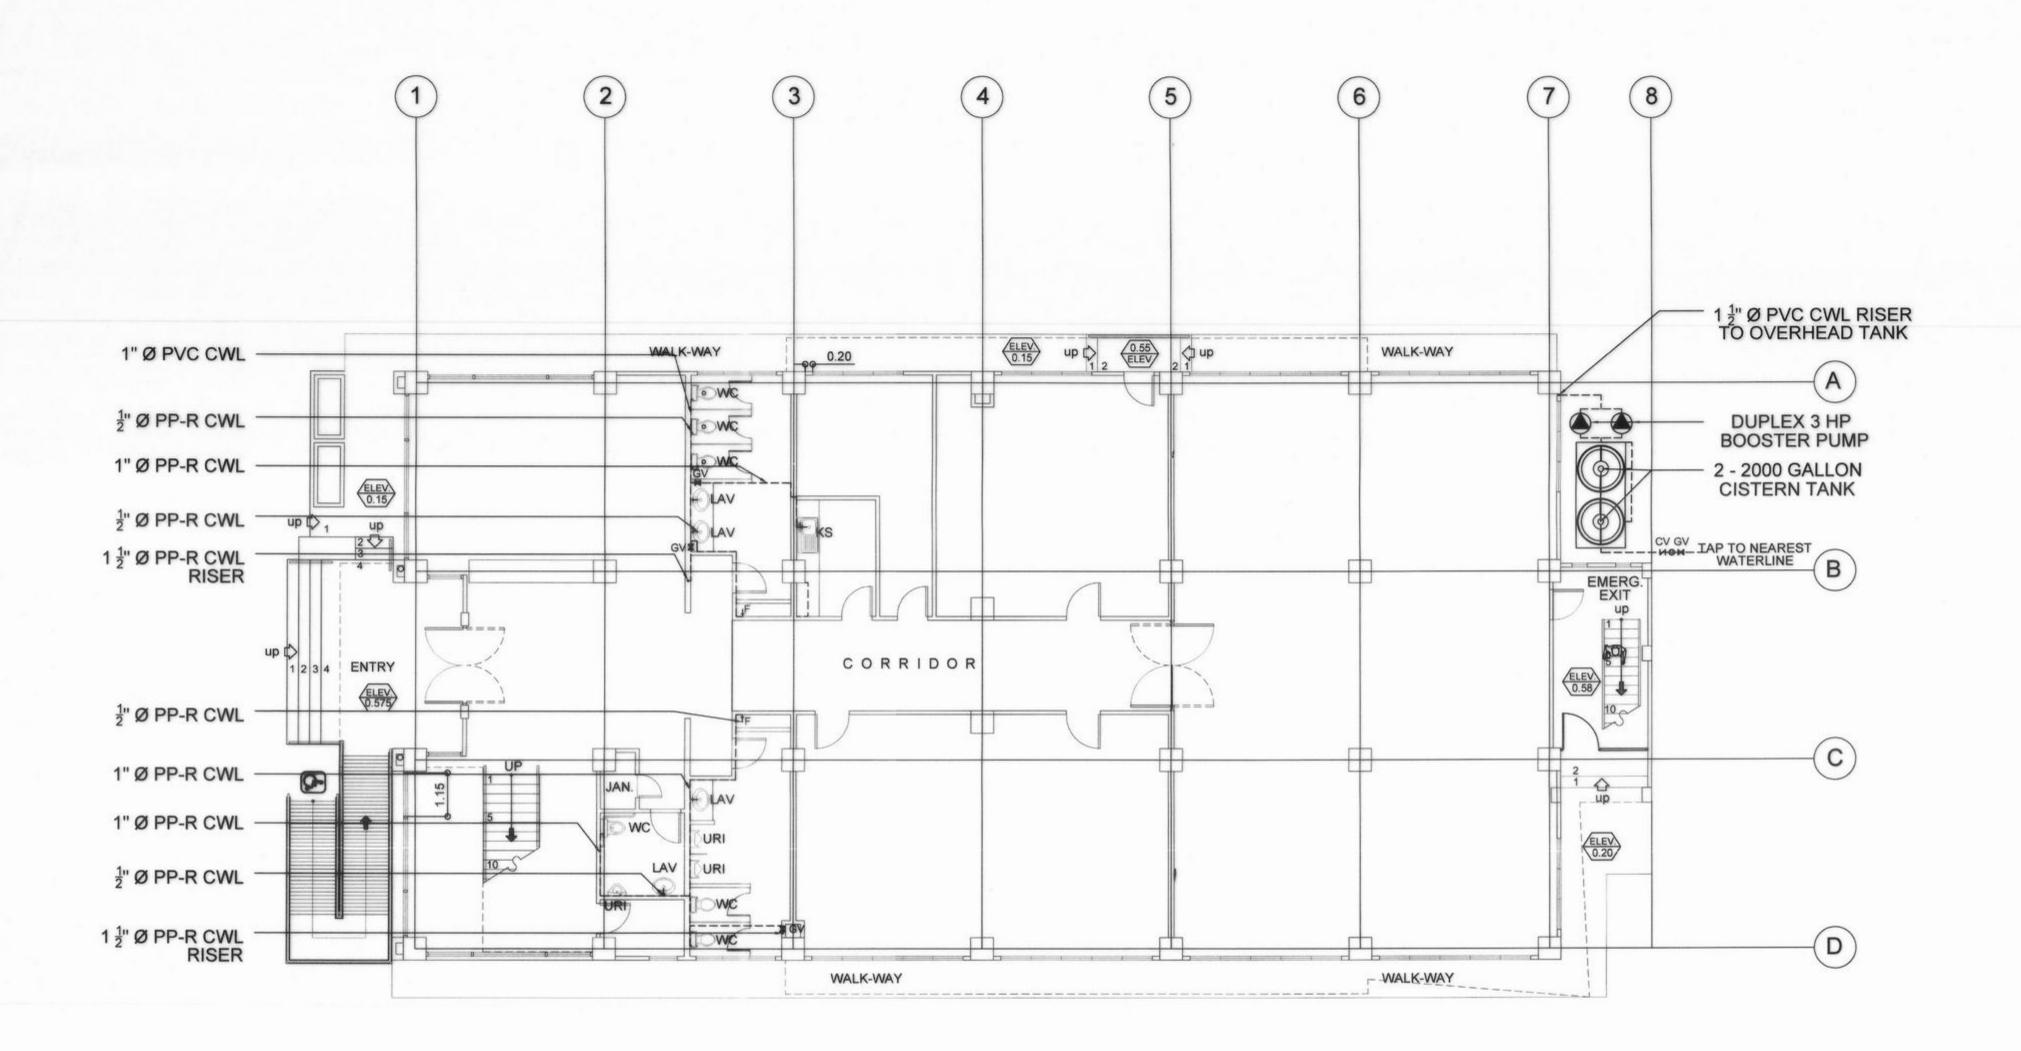

GROUND FLOOR WATERLINE LAYOUT

GENERAL NOTES

ALL PLUMBING WORKS INCLUDED HEREIN SHALL BE EXECUTED ACCORDING TO THE REQUIREMENTS OF THE UNIFORM PLUMBING CODE OF THE PHILIPPINES AND THE RULES AND REGULATIONS OF THE GOVERNMENT. NOTHING CONTAINED ON THE DRAWING SHALL BE CONSTRUCTED AS TO CONFLICT WITH THE NATIONAL AND LOCAL ORDINANCES OR LAWS GOVERNING THE IMPLEMENTATION OF THE PLUMBING WORKS.

REFER TO ALL ELECTRICAL, STRUCTURAL, AND ARCHITECTURAL PLANS AND SPECIFICATIONS AND INVESTIGATE ALL POSSIBLE INTERFERENCES AND CONDITIONS AFFECTING PLUMBING WORKS.

THE ENGINEER AND ARCHITECT SHALL BE IMMEDIATELY NOTIFIED FOR ANY DISCREPANCY FOUND THEREIN.

PIPES SHALL BE WITH PRIOR APPROVAL OF THE ARCHITECT AND ENGINEER.

PROPOSED SANITARY UTILITIES SHALL CONFORM WITH THE ACTUAL LOCATION, DEPTH, AND INVERT ELEVATION OF ALL EXISTING PIPES STRUCTURE.

ALL SLOPES FOR HORIZONTAL BRANCHES SHALL MAINTAIN 1% AS MINIMUM UNLESS STATED OTHERWISE.

ALL SEWER LINES SHALL BE UPVC PIPE SERIES 1000 BY EMERALD OR EQUIVALENT.

ALL VENT PIPES SHALL BE UPVC PIPE SERIES

ALL DOWNSPOUTS SHALL BE PVC PIPE SERIES 1000.

ALL COLD WATER LINES SHALL BE PPR PN-20

LEGENDS & SYMBOLS

WATER SUPPLY DISTRIBUTION SYSTEM

COLD WATERLINE GATE VALVE ─N cv CHECK VALVE **FAUCET & SHOWER** ____ F/SHO 0 RISER

WASTEWATER COLLECTION SYSTEM

VENT PIPE VENT PIPE ABOVE CEILING VPTW AC VENT THRU WALL ABOVE CL VENT STACK ABOVE CL.

SOIL PIPE

—⊚ co **CLEAN OUT** FLOOR DRAIN ——□ FD

0 PIPE STACK 0 WATER CLOSET

URINAL DRAIN PIPE

DOWNSPOUT ROOF DRAIN

DE

CATCH BASIN

0

CB

REPUBLIC OF THE PHILIPPINES COMMISSION ON AUDIT REGIONAL OFFICE NO. IX CABATANGAN, ZAMBOANGA CITY


RECOMMENDING APPROVAL:

VISITACION Q. MENDOZA DIRECTOR IV - REGIONAL DIRECTOR

PREPARED:

AMELIA P. VALDEZ
DIRECTOR IV - GENERAL SERVICES OFFICE

LORNA D. CABOCHAN

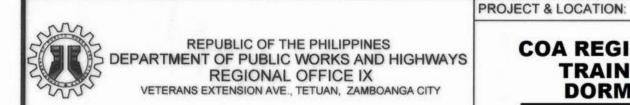

COA REGIONAL OFFICE NO. IX TRAINING CENTER AND **DORMITORY BUILDING** CABATANGAN, ZAMBOANGA CITY

SHEET CONTENT: GROUND FLOOR WATER LINE LAYOUT GENERAL NOTES LEGENDS AND SYMBOLS

AR-RAFIA. SALUAN PIO MARIO T. LACASTESANTOS CHIEF, BRIDGE & OTHER PUBLIC WORKS DESIGN SECTION REGISTERED SANITARY ENGINEER


REVIEWED:

RECOMMENDED: SUBMITTED: KHADAFFY D. NANGGOL SATURNINO C. TORREFRANCA DISTRICT ENGINEER OIC - CHIEF, PLANNING & DESIGN DIVISION ASSISTANT REGIONAL DIRECTOR


CAYAMOMBAO D. DIA, CESO IV

APPROVED:

APPROVED (BY THE AUTORITY OF THE CHAIRPERSON)

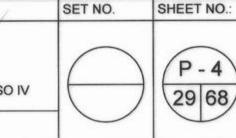

P-4

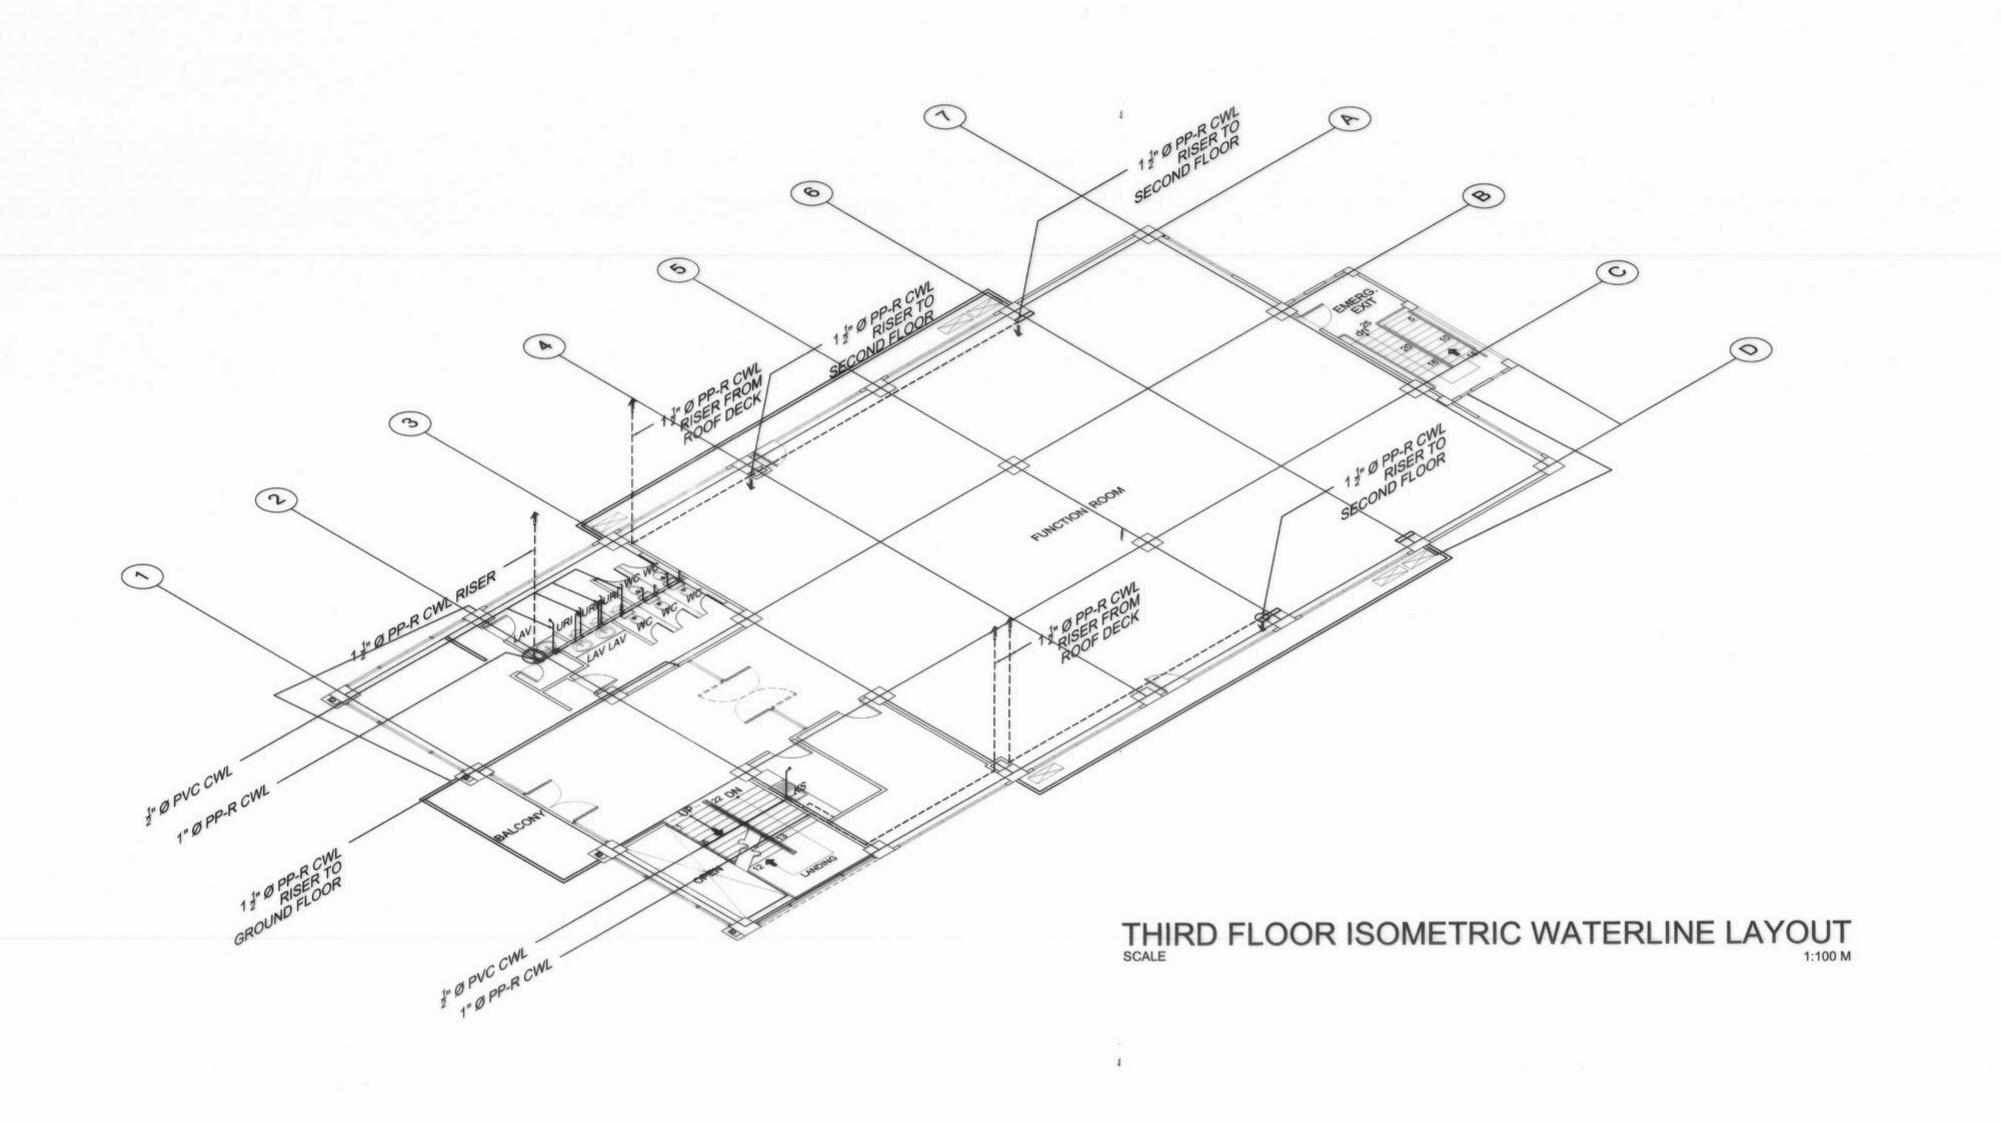

ALL PLUMBING WORKS INCLUDED HEREIN SHALL BE EXECUTED ACCORDING TO THE REQUIREMENTS OF THE UNIFORM PLUMBING CODE OF THE PHILIPPINES AND THE RULES AND REGULATIONS OF THE GOVERNMENT. NOTHING CONTAINED ON THE DRAWING SHALL BE CONSTRUCTED AS TO CONFLICT WITH THE NATIONAL AND LOCAL ORDINANCES OR LAWS GOVERNING THE IMPLEMENTATION OF THE PLUMBING WORKS.

REFER TO ALL ELECTRICAL, STRUCTURAL, AND ARCHITECTURAL PLANS AND SPECIFICATIONS AND INVESTIGATE ALL POSSIBLE INTERFERENCES AND CONDITIONS AFFECTING PLUMBING WORKS.

THE ENGINEER AND ARCHITECT SHALL BE IMMEDIATELY NOTIFIED FOR ANY DISCREPANCY FOUND THEREIN.

PIPES SHALL BE WITH PRIOR APPROVAL OF THE ARCHITECT AND ENGINEER.

PROPOSED SANITARY UTILITIES SHALL CONFORM WITH THE ACTUAL LOCATION, DEPTH, AND INVERT ELEVATION OF ALL EXISTING PIPES STRUCTURE.

ALL SLOPES FOR HORIZONTAL BRANCHES SHALL MAINTAIN 1% AS MINIMUM UNLESS STATED OTHERWISE.

ALL SEWER LINES SHALL BE UPVC PIPE SERIES 1000 BY EMERALD OR EQUIVALENT.

ALL VENT PIPES SHALL BE UPVC PIPE SERIES

ALL DOWNSPOUTS SHALL BE PVC PIPE SERIES

ALL COLD WATER LINES SHALL BE PPR PN-20 TYPE THERMOVAR OR EQUIVLENT.

LEGENDS & SYMBOLS

WATER SUPPLY DISTRIBUTION SYSTEM

COLD WATERLINE —₩— GV GATE VALVE ─N cv CHECK VALVE - F/SHO FAUCET & SHOWER

RISER

WASTEWATER COLLECTION SYSTEM

SOIL PIPE **VENT PIPE** VENT PIPE ABOVE CEILING

VPTW AC VENT THRU WALL ABOVE CL. VENT STACK ABOVE CL.

— © со _____ FD 0

CLEAN OUT FLOOR DRAIN

PIPE STACK WC WATER CLOSET URINAL

0 RD

DRAIN PIPE DOWNSPOUT **ROOF DRAIN**

CATCH BASIN

CB

LORNA D. CABOCHAN



REPUBLIC OF THE PHILIPPINES DEPARTMENT OF PUBLIC WORKS AND HIGHWAYS REGIONAL OFFICE IX VETERANS EXTENSION AVE., TETUAN, ZAMBOANGA CITY

REPUBLIC OF THE PHILIPPINES COMMISSION ON AUDIT **REGIONAL OFFICE NO. IX**

CABATANGAN, ZAMBOANGA CITY

PROJECT & LOCATION:

COA REGIONAL OFFICE NO. IX **TRAINING CENTER AND DORMITORY BUILDING**

CABATANGAN, ZAMBOANGA CITY

THIRD FLOOR ISOMETRIC -WATERLINE LAYOUT GENERAL NOTES LEGENDS AND SYMBOLS

SHEET CONTENT:

RECOMMENDING APPROVAL:

AR-RAFI A. SALUAN REGISTERED SANITARY ENGINEER

VISITACION Q. MENDOZA DIRECTOR IV - REGIONAL DIRECTOR

PREPARED:

PIO MARIO T. LACASTESANTOS CHIEF, BRIDGE & OTHER PUBLIC WORKS DESIGN SECTION

REVIEWED:

AMELIA P. VALDEZ

RECOMMENDED: SUBMITTED: SATURNINO C. TORREFRANCA DISTRICT ENGINEER OIC - CHIEF, PLANNING & DESIGN DIVISION

KHADAFFY DYTANGGOL ASSISTANT REGIONAL DIRECTOR


APPROVED (BY THE AUTORITY OF THE CHAIRPERSON):

CAYAMOMBAO D. DIA, CESO IV REGIONAL DIRECTOR

APPROVED:



SHEET NO.

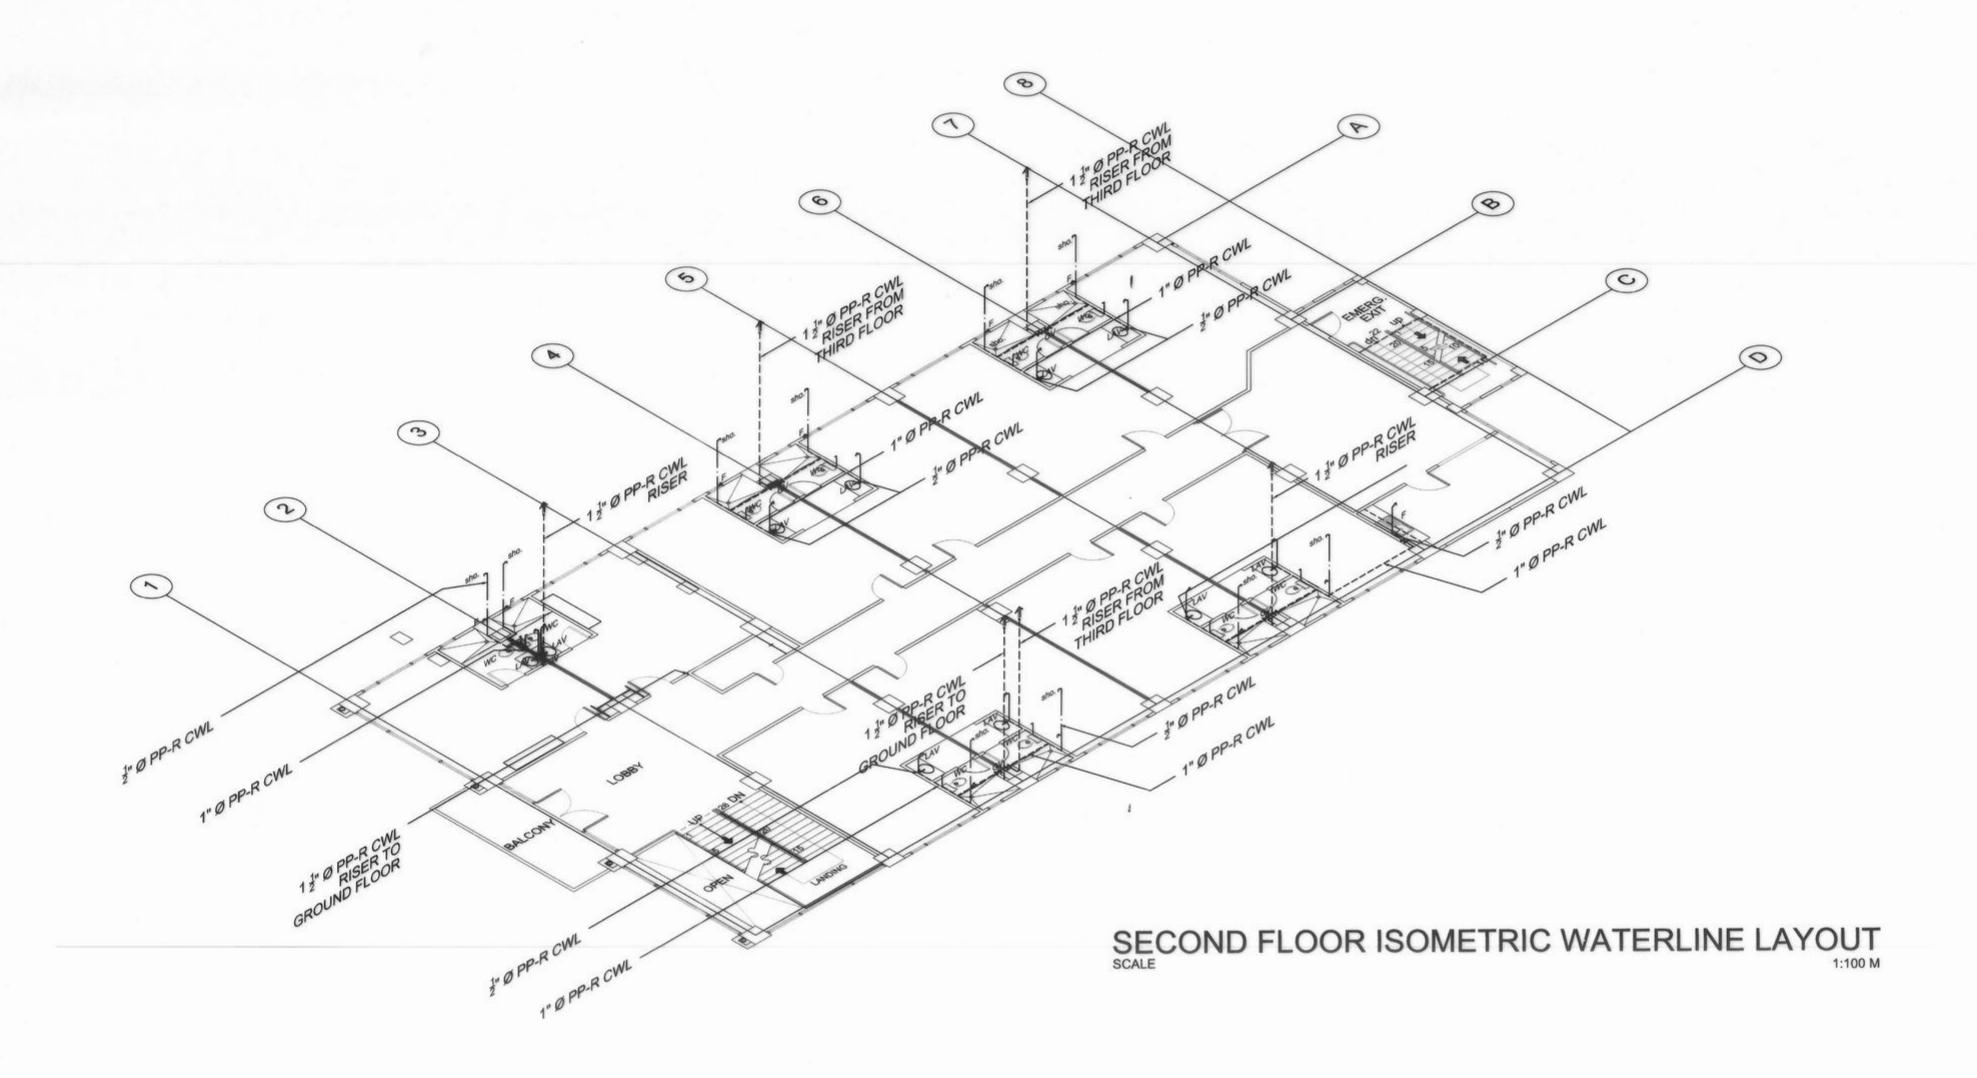

ALL PLUMBING WORKS INCLUDED HEREIN SHALL BE EXECUTED ACCORDING TO THE REQUIREMENTS OF THE UNIFORM PLUMBING CODE OF THE PHILIPPINES AND THE RULES AND REGULATIONS OF THE GOVERNMENT. NOTHING CONTAINED ON THE DRAWING SHALL BE CONSTRUCTED AS TO CONFLICT WITH THE NATIONAL AND LOCAL ORDINANCES OR LAWS GOVERNING THE IMPLEMENTATION OF THE PLUMBING WORKS.

REFER TO ALL ELECTRICAL, STRUCTURAL, AND ARCHITECTURAL PLANS AND SPECIFICATIONS AND INVESTIGATE ALL POSSIBLE INTERFERENCES AND CONDITIONS AFFECTING PLUMBING WORKS.

THE ENGINEER AND ARCHITECT SHALL BE IMMEDIATELY NOTIFIED FOR ANY DISCREPANCY FOUND THEREIN.

PIPES SHALL BE WITH PRIOR APPROVAL OF THE ARCHITECT AND ENGINEER.

PROPOSED SANITARY UTILITIES SHALL CONFORM WITH THE ACTUAL LOCATION, DEPTH, AND INVERT ELEVATION OF ALL EXISTING PIPES STRUCTURE.

ALL SLOPES FOR HORIZONTAL BRANCHES SHALL MAINTAIN 1% AS MINIMUM UNLESS STATED OTHERWISE.

ALL SEWER LINES SHALL BE UPVC PIPE SERIES 1000 BY EMERALD OR EQUIVALENT.

ALL VENT PIPES SHALL BE UPVC PIPE SERIES

ALL DOWNSPOUTS SHALL BE PVC PIPE SERIES

ALL COLD WATER LINES SHALL BE PPR PN-20 TYPE THERMOVAR OR EQUIVLENT.

LEGENDS & SYMBOLS

WATER SUPPLY DISTRIBUTION SYSTEM

COLD WATERLINE GATE VALVE ──N cv CHECK VALVE - F/SHO FAUCET & SHOWER

WASTEWATER COLLECTION SYSTEM

SOIL PIPE **VENT PIPE** VENT PIPE ABOVE CEILING VPTW AC VENT THRU WALL ABOVE CL. VENT STACK ABOVE CL. —— © со **CLEAN OUT** FLOOR DRAIN 0 PIPE STACK WATER CLOSET

URINAL

DRAIN PIPE RD

DOWNSPOUT **ROOF DRAIN**

0

CATCH BASIN

CB



REPUBLIC OF THE PHILIPPINES COMMISSION ON AUDIT **REGIONAL OFFICE NO. IX** CABATANGAN, ZAMBOANGA CITY

PROJECT & LOCATION:

RECOMMENDING APPROVAL:

AMELIA P. VALDEZ
DIRECTOR IV - GENERAL SERVICES OFFICE

LORNA D. CABOCHAN
ASSISTANT COMMISSIONER - ADMINISTRATION SECTOR

REPUBLIC OF THE PHILIPPINES S DEPARTMENT OF PUBLIC WORKS AND HIGHWAYS REGIONAL OFFICE IX VETERANS EXTENSION AVE., TETUAN, ZAMBOANGA CITY

COA REGIONAL OFFICE NO. IX TRAINING CENTER AND DORMITORY BUILDING CABATANGAN, ZAMBOANGA CITY

SECOND FLOOR ISOMETRIC -WATERLINE LAYOUT GENERAL NOTES LEGENDS AND SYMBOLS

SHEET CONTENT:

AR-RAFIA. SALUAN REGISTERED SANITARY ENGINEER

VISITACION Q. MENDOZA DIRECTOR IV - REGIONAL DIRECTOR

PREPARED:

PIO MARIO T DACASTESANTOS CHIEF, BRIDGE & OTHER PUBLIC WORKS DESIGN SECTION

REVIEWED:

SATURNINO C. TORREFRANCA DISTRICT ENGINEER OIC - CHIEF, PLANNING & DESIGN DIVISION

SUBMITTED:

KHADAFFY DUTANGGOL


RECOMMENDED:

APPROVED (BY THE AUTORITY OF THE CHAIRPERSON)

CAYAMOMBAO D. DIA, CESO IV REGIONAL DIRECTOR

APPROVED:

SHEET NO.

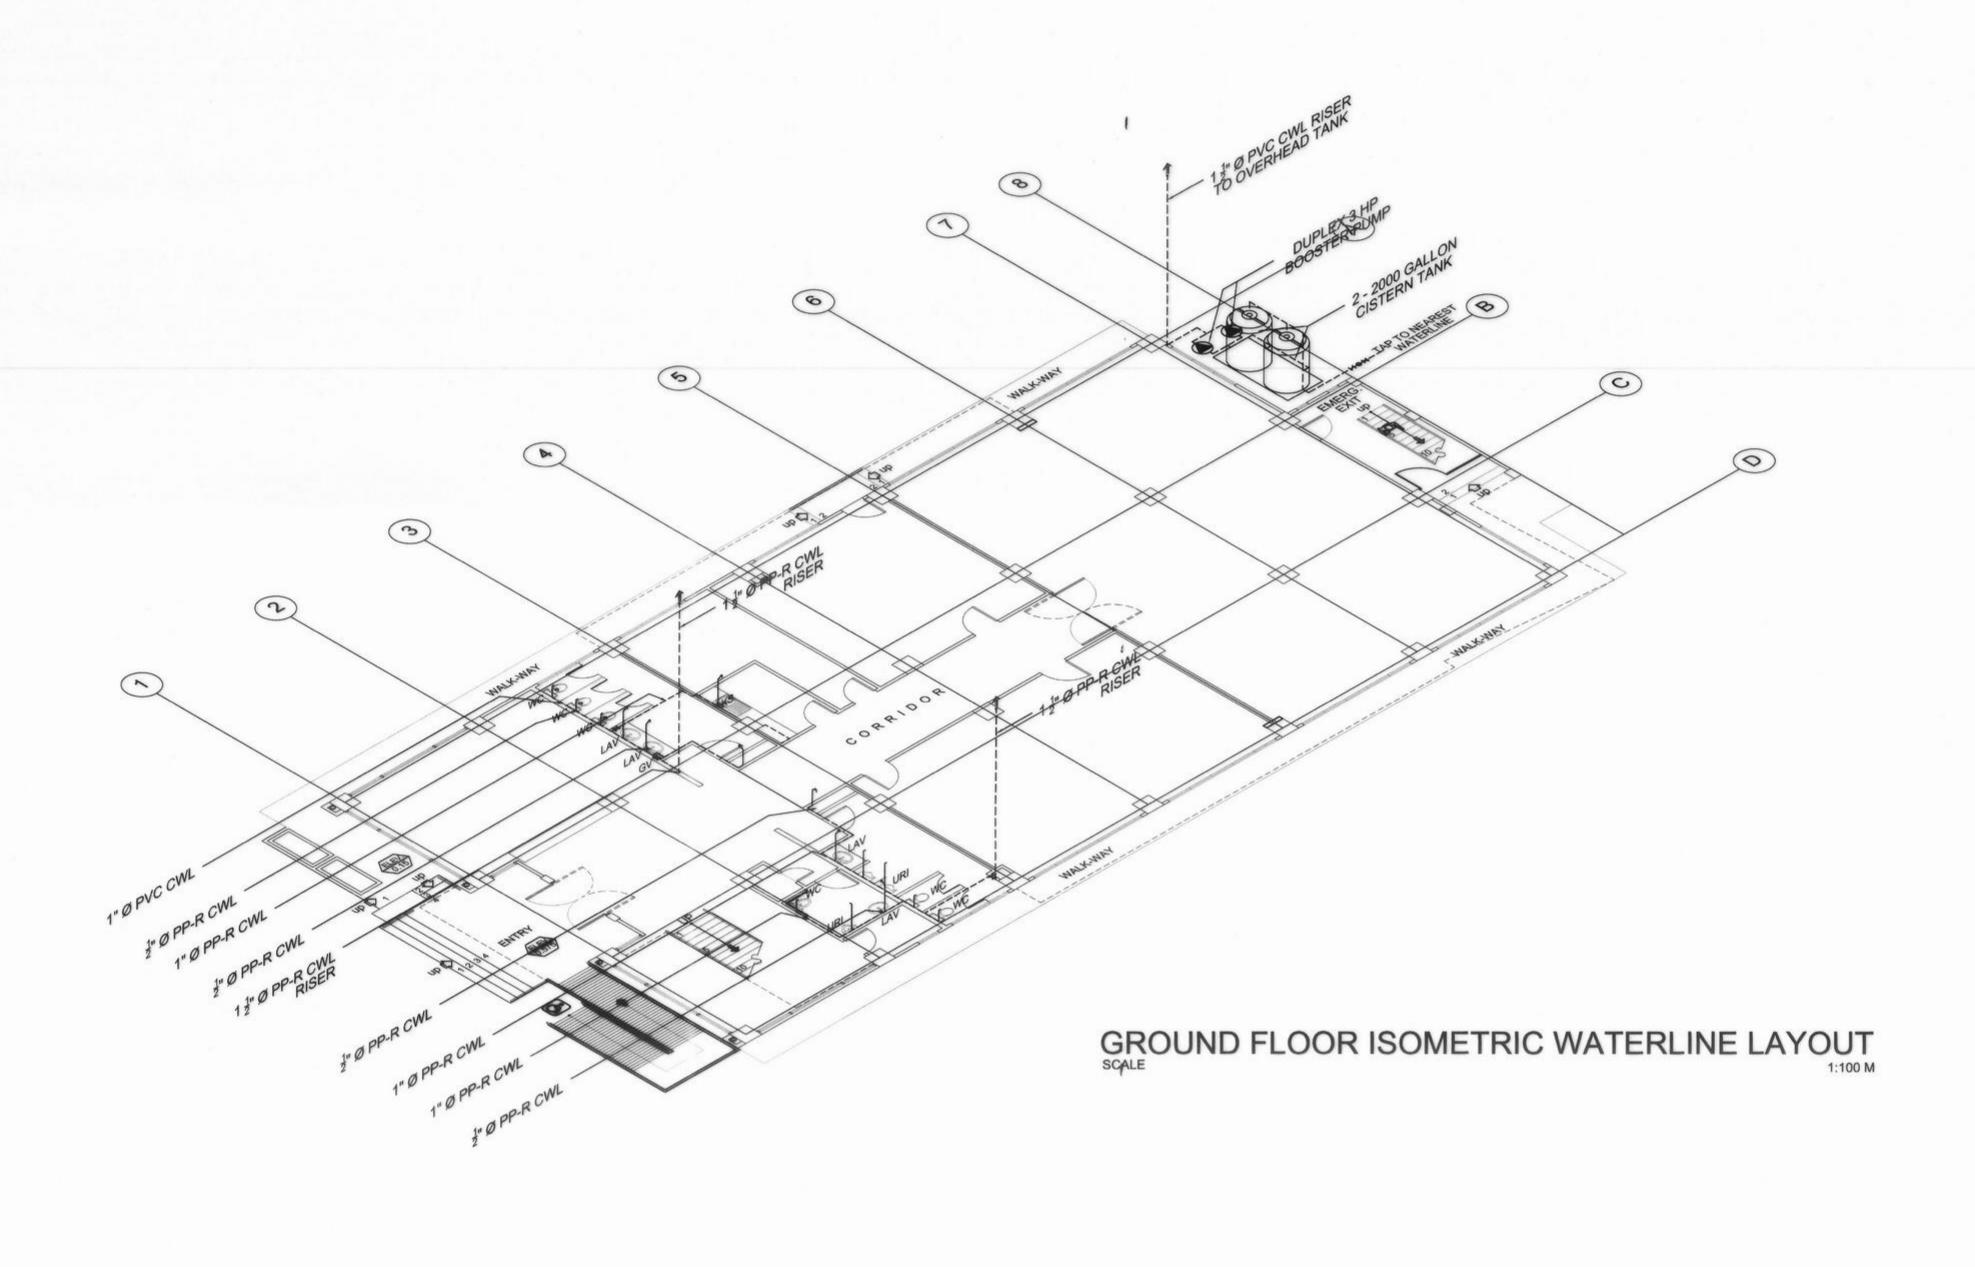

ALL PLUMBING WORKS INCLUDED HEREIN SHALL BE EXECUTED ACCORDING TO THE REQUIREMENTS OF THE UNIFORM PLUMBING CODE OF THE PHILIPPINES AND THE RULES AND REGULATIONS OF THE GOVERNMENT. NOTHING CONTAINED ON THE DRAWING SHALL BE CONSTRUCTED AS TO CONFLICT WITH THE NATIONAL AND LOCAL ORDINANCES OR LAWS GOVERNING THE IMPLEMENTATION OF THE PLUMBING WORKS.

REFER TO ALL ELECTRICAL, STRUCTURAL, AND ARCHITECTURAL PLANS AND SPECIFICATIONS AND INVESTIGATE ALL POSSIBLE INTERFERENCES AND CONDITIONS AFFECTING PLUMBING WORKS.

THE ENGINEER AND ARCHITECT SHALL BE IMMEDIATELY NOTIFIED FOR ANY DISCREPANCY FOUND THEREIN.

PIPES SHALL BE WITH PRIOR APPROVAL OF THE ARCHITECT AND ENGINEER.

PROPOSED SANITARY UTILITIES SHALL CONFORM WITH THE ACTUAL LOCATION, DEPTH, AND INVERT ELEVATION OF ALL EXISTING PIPES STRUCTURE.

ALL SLOPES FOR HORIZONTAL BRANCHES SHALL MAINTAIN 1% AS MINIMUM UNLESS STATED OTHERWISE.

ALL SEWER LINES SHALL BE UPVC PIPE SERIES 1000 BY EMERALD OR EQUIVALENT.

ALL VENT PIPES SHALL BE UPVC PIPE SERIES 1000.

ALL DOWNSPOUTS SHALL BE PVC PIPE SERIES

ALL COLD WATER LINES SHALL BE PPR PN-20 TYPE THERMOVAR OR EQUIVLENT.

LEGENDS & SYMBOLS

WATER SUPPLY DISTRIBUTION SYSTEM

-		CWL	COLD WATERLINE
1	$-\bowtie$	GV	GATE VALVE
-	N	CV	CHECK VALVE
-		F/SHO	FAUCET & SHOWER
1	0		RISER

WASTEWATER COLLECTION SYSTEM

SOIL PIPE **VENT PIPE** VENT PIPE ABOVE CEILING VPTW AC VENT THRU WALL ABOVE CL. VENT STACK ABOVE CL. —• co **CLEAN OUT** —□ FD FLOOR DRAIN 0 PIPE STACK

WATER CLOSET URINAL

DRAIN PIPE DOWNSPOUT 0 RD **ROOF DRAIN**

DE CB CATCH BASIN

APPROVED:

APPROVED (BY THE AUTORITY OF THE CHAIRPERSON)



REPUBLIC OF THE PHILIPPINES COMMISSION ON AUDIT REGIONAL OFFICE NO. IX CABATANGAN, ZAMBOANGA CITY

PROJECT & LOCATION:

VISITACION Q. MENDOZA DIRECTOR IV - REGIONAL DIRECTOR

RECOMMENDING APPROVAL:

AMELIA P. VALDEZ
DIRECTOR IV - GENERAL SERVICES OFFICE

LORNA D. CABOCHAN
ASSISTANT COMMISSIONER - ADMINISTRATION SECTOR

REPUBLIC OF THE PHILIPPINES DEPARTMENT OF PUBLIC WORKS AND HIGHWAYS REGIONAL OFFICE IX VETERANS EXTENSION AVE., TETUAN, ZAMBOANGA CITY

COA REGIONAL OFFICE NO. IX TRAINING CENTER AND DORMITORY BUILDING CABATANGAN, ZAMBOANGA CITY

PREPARED: SHEET CONTENT: GROUND FLOOR ISOMETRIC -WATERLINE LAYOUT GENERAL NOTES AR-RAFI A. SALUAN LEGENDS AND SYMBOLS REGISTERED SANITARY ENGINEER

PIO MARIO TILACASTESANTOS CHIEF, BRIDGE & OTHER PUBLIC WORKS DESIGN SECTION

REVIEWED:


SATURNINO C. TORREFRANCA DISTRICT ENGINEER OIC - CHIEF, PLANNING & DESIGN DIVISION

SUBMITTED:

KHADAFFY DATANGGOL ASSISTANT REGIONAL DIRECTOR


RECOMMENDED:


CAYAMOMBAO D. DIA, CESO IV REGIONAL DIRECTOR

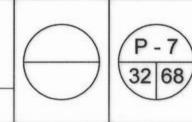

SHEET NO .:

SET NO.

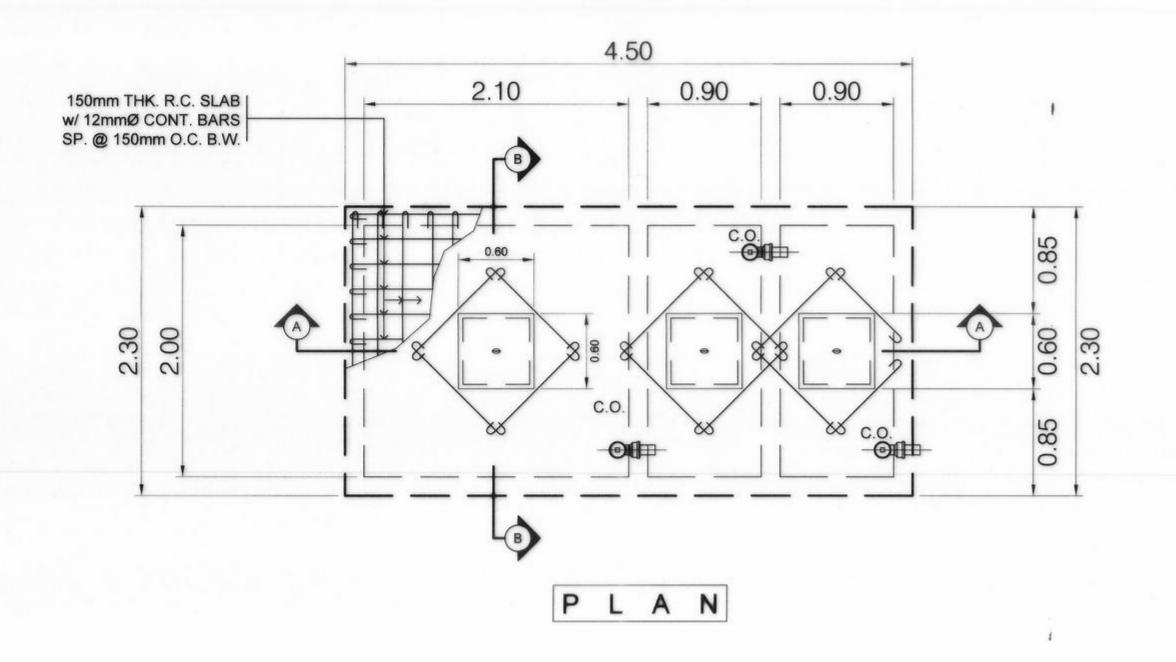

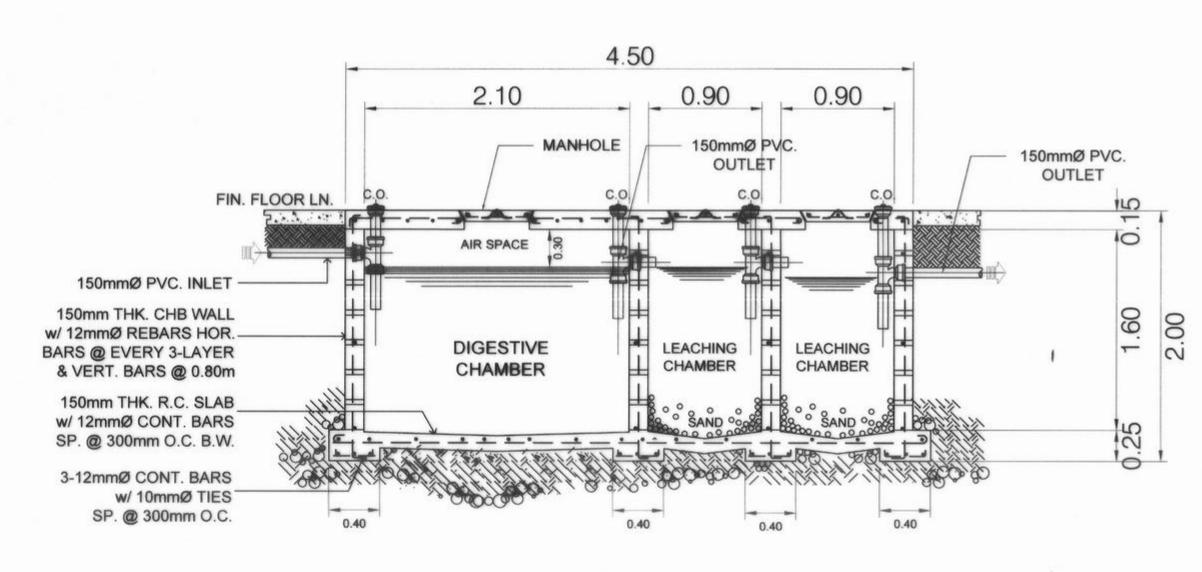

150mm THK. CHB WALL
W/ 12mmØ REBARS HOR.
BARS @ EVERY 3-LAYER
& VERT. BARS @ 0.80m

150mm THK. R.C. SLAB
W/ 12mmØ CONT. BARS
SP. @ 300mm O.C. B.W.

SECTION B-B

2.30

2.00

MANHOLE

DETAILS OF SEPTIC VAULT

150mmØ PVC. OUTLET

SECTION A-A

SHEET CONTENT:



REPUBLIC OF THE PHILIPPINES

COMMISSION ON AUDIT

REGIONAL OFFICE NO. IX

PROJECT & LOCATION:

CABATANGAN, ZAMBOANGA CITY

RECOMMENDING APPROVAL :

APPROVED (BY THE AUTORITY OF THE CHAIRPERSON)

RECOMMENDED:

VISITACION Q. MENDOZA DIRECTOR IV - REGIONAL DIRECTOR AMELIA P. VALDEZ
DIRECTOR IV - GENERAL SERVICES OFFICE

SUBMITTED:

LORNA D. CABOCHAN
ASSISTANT COMMISSIONER - ADMINISTRATION SECTOR

REPUBLIC OF THE PHILIPPINES
DEPARTMENT OF PUBLIC WORKS AND HIGHWAYS
REGIONAL OFFICE IX
VETERANS EXTENSION AVE., TETUAN, ZAMBOANGA CITY

COA REGIONAL OFFICE NO. IX
TRAINING CENTER AND
DORMITORY BUILDING
CABATANGAN, ZAMBOANGA CITY

DETAILS OF SEPTIC VAULT

AR-RAFI A. SALUAN
ENGINEERING AIDE
REGISTERED SANITARY ENGINEER

PREPARED:

PIO MARIO T LACASTESANTOS
ENGINEER III
CHIEF, BRIDGE NOTHER PUBLIC WORKS DESIGN SECTION


REVIEWED:


SATURNINO C. TORREFRANCA
DISTRICT ENGINEER
OIC - CHIEF, PLANNING & DESIGN DIVISION

KHADAFFY B TANGGOL
ASSISTANT REGIONAL DIRECTOR

CAYAMOMBAO D. DIA, CESO IV

APPROVED:

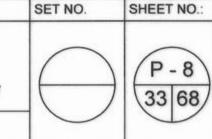

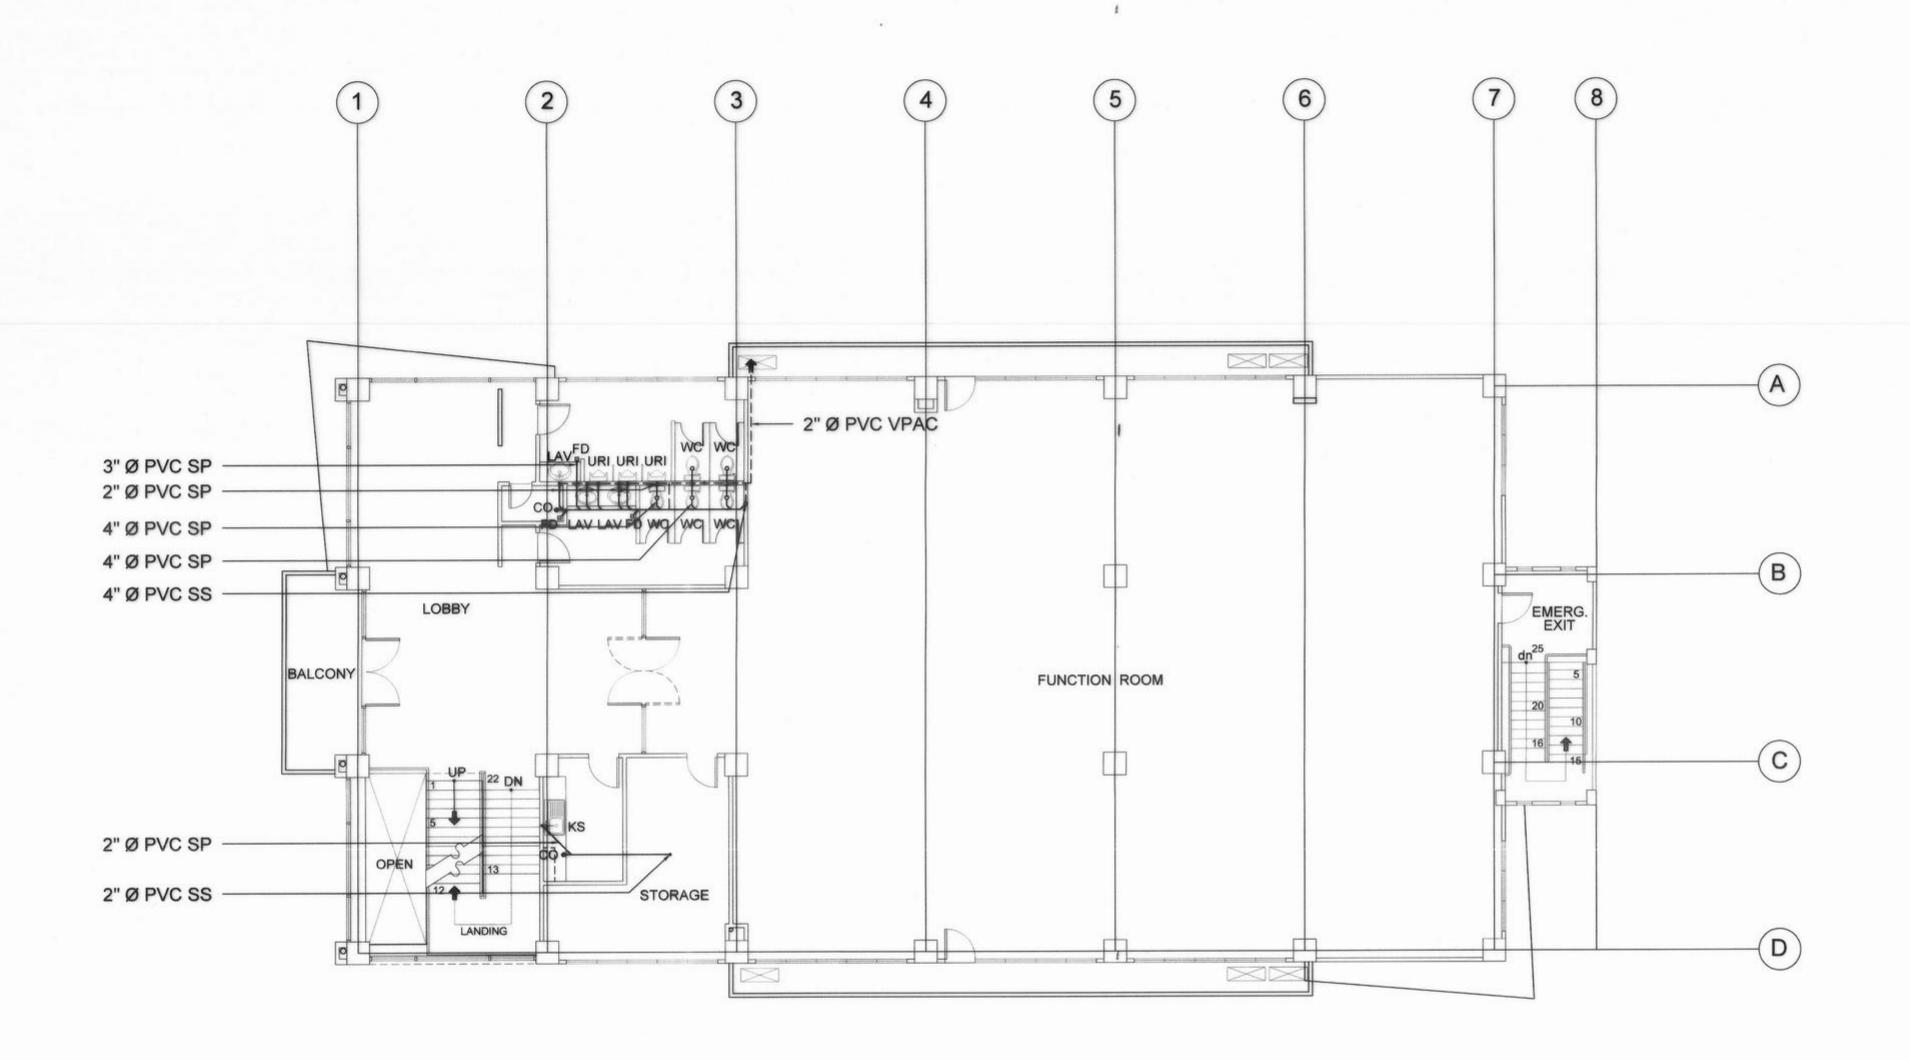

THIRD FLOOR SANITARY LAYOUT

SUBMITTED:

GENERAL NOTES

ALL PLUMBING WORKS INCLUDED HEREIN SHALL BE EXECUTED ACCORDING TO THE REQUIREMENTS OF THE UNIFORM PLUMBING CODE OF THE PHILIPPINES AND THE RULES AND REGULATIONS OF THE GOVERNMENT. NOTHING CONTAINED ON THE DRAWING SHALL BE CONSTRUCTED AS TO CONFLICT WITH THE NATIONAL AND LOCAL ORDINANCES OR LAWS GOVERNING THE IMPLEMENTATION OF THE PLUMBING WORKS.

REFER TO ALL ELECTRICAL, STRUCTURAL, AND ARCHITECTURAL PLANS AND SPECIFICATIONS AND INVESTIGATE ALL POSSIBLE INTERFERENCES AND CONDITIONS AFFECTING PLUMBING WORKS.

THE ENGINEER AND ARCHITECT SHALL BE IMMEDIATELY NOTIFIED FOR ANY DISCREPANCY FOUND THEREIN.

PIPES SHALL BE WITH PRIOR APPROVAL OF THE ARCHITECT AND ENGINEER.

PROPOSED SANITARY UTILITIES SHALL CONFORM WITH THE ACTUAL LOCATION, DEPTH, AND INVERT ELEVATION OF ALL EXISTING PIPES STRUCTURE.

ALL SLOPES FOR HORIZONTAL BRANCHES SHALL MAINTAIN 1% AS MINIMUM UNLESS STATED OTHERWISE.

ALL SEWER LINES SHALL BE UPVC PIPE SERIES 1000 BY EMERALD OR EQUIVALENT.

ALL VENT PIPES SHALL BE UPVC PIPE SERIES 1000.

ALL DOWNSPOUTS SHALL BE PVC PIPE SERIES 1000.

ALL COLD WATER LINES SHALL BE PPR PN-20 TYPE THERMOVAR OR EQUIVLENT.

LEGENDS & SYMBOLS

WATER SUPPLY DISTRIBUTION SYSTEM

CWL COLD WATERLINE

GV GATE VALVE

CHECK VALVE

F/SHO FAUCET & SHOWER

RISER

WASTEWATER COLLECTION SYSTEM

SOIL PIPE **VENT PIPE** VENT PIPE ABOVE CEILING VPTW AC VENT THRU WALL ABOVE CL VENT STACK ABOVE CL. —**⊚** co CLEAN OUT ______ FD FLOOR DRAIN 0 PIPE STACK D WATER CLOSET URINAL DRAIN PIPE DOWNSPOUT

DP DRAIN PIPE
DS DOWNSPOUT
O RD ROOF DRAIN
CB CATCH BASIN



REPUBLIC OF THE PHILIPPINES

COMMISSION ON AUDIT

REGIONAL OFFICE NO. IX

CABATANGAN, ZAMBOANGA CITY

PROJECT & LOCATION:

RECOMMENDING APPROVAL :

VISITACION Q. MENDOZA

DIRECTOR IV - REGIONAL DIRECTOR

AMELIA P. VALDEZ

_

APPROVED:

LORNA D. CABOCHAN
ASSISTANT COMMISSIONER - ADMINISTRATION SECTOR

REPUBLIC OF THE PHILIPPINES
DEPARTMENT OF PUBLIC WORKS AND HIGHWAYS
REGIONAL OFFICE IX
VETERANS EXTENSION AVE., TETUAN, ZAMBOANGA CITY

COA REGIONAL OFFICE NO. IX
TRAINING CENTER AND
DORMITORY BUILDING
CABATANGAN, ZAMBOANGA CITY

SHEET CONTENT: PREPARED:
THIRD FLOOR SANITARY LAYOUT
GENERAL NOTES
LEGENDS AND SYMBOLS
AI

AR-RAFIA. SALUAN
ENGINEERING AIDE

REGISTERED SANITARY ENGINEER

PIO MARIO T. LACASTESANTOS
ENGINEER III

CHIEF, BRÍDGE & OTHER PUBLIC WORKS DESIGN SECTION

REVIEWED:


SATURNINO C. TORREFRANCA
DISTRICT ENGINEER
OIC - CHIEF, PLANNING & DESIGN DIVISION

KHADAFFY D. TANGGOL
ASSISTANT REGIONAL DIRECTOR

RECOMMENDED:

APPROVED (BY THE AUTORITY OF THE CHAIRPERSON):

CAYAMOMBAO D. DIA, CESO IV

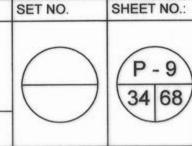

GENERAL CONSTRUCTION NOTES

GENERAL NOTES

- 1. IN THE INTERPRETATION OF THE DRAWING, INDICATED DIMENSIONS SHALL GOVERN AND DISTANCES OF SIZES SHALL NOT BE SCALED FOR CONSTRUCTION PURPOSES.
- 2. IN REFERENCE TO OTHER DRAWINGS, SEE ARCHITECTURAL DRAWINGS FOR DEPRESSIONS IN FLOOR SLABS, OPENINGS IN THE WALLS AND SLABS, INTERIOR PARTIONS, LOCATION
- 3. IN CASE OF DISCREPANCIES AS TO THE LAYOUT, DIMENSIONS, AND ELEVATIONS BETWEEN THE STRUCTURAL PLANS, AND ARCHITECTURAL DRAWINGS, THE CONTRACTOR SHALL NOTIFY BOTH THE STRUCTURAL ENGINEERS AND THE ARCHITECT.
- 4. ALL CONCRETE WORKS SHALL BE DONE IN ACCORDANCE WITH THE ACI.318 95 BUILDING CODE REQUIREMENTS FOR REINFORCED CONCRETE AND ALL STRUCTURAL STEEL WORK ACCORDING WITH ASCI SPECIFICATION (9th EDITION) IN SO FAR AS THEY DO NOT CONFLICT WITH THE LOCAL BUILDING CODE REQUIREMENT.
- 5. ACI REFERS TO AMERICAN CONCRETE INSTITUTE, ASCI TO AMERICAN INSTITUTE OF STEEL CONSTRUCTION AND ASTM TO AMERICAN SOCIETY FOR TESTING MATERIALS.
- CONSTRUCTION NOTES AND TYPICAL DETAILS APPLY TO ALL DRAWINGS UNLESS OTHERWISE SHOWN OR NOTED MODIFY TYPICAL DETAILS AS DIRECTED TO MEET SPECIAL CONDITIONS.
- 7. SHOP DRAWINGS WITH ERECTION AND PLACING DIAGRAMS OF ALL STRUCTURAL STEELS. MISCELLANEOUS IRON, PRE-CAST CONCRETE ETC. SHALL BE SUBMITTED FOR ENGINEERS APPROVAL BEFORE FABRICATION
- 8. CONTRACTOR SHALL NOTE AND PROVIDE ALL MISCELLANEOUS CURBS, SILLS, STOOLS, EQUIPMENT'S AND MECHANICAL BASES THAT ARE REQUIRED BY THE ARCHITECTURAL, ELECTRICAL, AND MECHANICAL DRAWINGS.
- 9. ALL RESULTS OF MATERIAL TESTING FOR CONCRETE, REINFORCING BARS, & STRUCTURAL STEEL MUST BE NOTED & APPROVED BY THE STRUCTURAL DESIGNER.

NOTES ON CONCRETE MIXES & PLACING

LOCATION

1. ALL CONCRETE SHALL DEVELOP A MIN. COMPRESSIVE STRENGTH AT THE END OF TWENTY EIGHT (28) DAYS W/ CORRESPONDING MAXIMUM SIZE AGGREGATE & SLUMPS AS FOLLOWS.

28 DAYS STRENGTH MAX. SIZE OF MAX. SLUMP

			AGGREG	AIE	
COLUMNS	4000 PSI (2	7.6 MPa)	19mm		100mm
BEAMS & SUSPENDED SLA	AB4000 PSI (2	7.6 MPa)	19mm		100mm
SLAB ON GRADE	3000 PSI (2	1 MPa)	19mm		100mm
OTHERS NOT INDICATED	4000 PSI (2	7.6 MPa)	19mm		100mm
2. MAINTAIN MINIMUM CONCE SUSPENDED SLABS	IMN TIES DSED TO IST FORMS	FOR REINF		EEL AS I 20mm 40mm 25mm 40mm	FOLLOWS.
DIRECTLY AGAINST EARTH				75mm	

- 3. CONCTRETE SHALL BE DEPOSITED IN ITS FINAL POSITION WITHOUT SEGREGATION. RE-HAND LING OR FLOWING PLACING SHALL BE DONE PREFERABLY WITH BUGGIES, BUCKETS OR WHEELBARROWS, NO CHUTES WILL BE ALLOWED EXCEPT TO TRANSFER CONCRETE FROM HOPPERS TO BUGGIES, WHEELBARROWS OR BUCKETS IN WHICH CASE THEY SHALL NOT EXCEED SIX (6) METERS IN AGGREGATE LENGTH.
- 4. NO DEPOSITING OF CONCRETE SHALL BE ALLOWED WITHOUT THE USE OF VIBRATORS UNLESS AUTORIZED IN WRITING BY THE DESIGNERS AND ONLY FOR UNUSUAL CONDITIONS WHERE VIBRATIONS IS EXTREMELY DIFFICULT TO ACCOMPLISH.
- 5. ALL ANCHOR BOLTS, DOWELS, AND OTHER INSERTS, SHALL BE PROPERLY POSITIONED & SECURED IN PLACE PRIOR TO PLACING OF CONCRETE.
- 6. ALL CONCRETE SHALL BE KEPT MOIST FOR A MINIMUM OF SEVEN CONSECUTIVE DAYS IMMEDIATELY AFTER POURING BY THE USE OF WET BURLAP FOG SPRAYING, CURING COMPOUNDS OR OTHER APPROVED METHODS.

7. STRIPPING OF FORMS AND SHORES:	
FOUNDATION	24 HRS.
SUSPENDED SLAB EXCEPT WHEN	
ADDITIONAL LOADS ARE IMPOSED	14 DAYS
WALLS	21 DAYS
BEAMS	14 DAYS

- 8. THE CONTRACTOR SHALL SUBMIT THE SCHEDULE OF POURING AND THE LOCATION OF THE CONSTRUCTION JOINTS TO THE STRUCTURAL ENGINEER AT LEAST (4) DAYS PRIOR TO THE
- 9. THE CONTRACTOR SHALL FURNISH AND MAINTAIN ADEQUATE FORMS SHORINGS UNTIL THE CONCRETE MEMBERS HAVE ATTAINED THEIR WORKING CONDITION AND STRENGTH.

NOTES OF FOOTINGS

COLUMNS -


- 1. FOOTINGS ARE DESIGNED FOR AN ALLOWABLE SOIL BEARING PRESSURE OF 95KPa. CONTRACTOR SHALL REPORT TO THE ENGINEER, IN WRITING, SOIL CONDITIONS, UNCOVERED AND CONFIRM ACTUAL BEARING CAPACITY OF SOIL BEFORE DEPOSITING CONCRETE
- 2. FOOTING SHALL REST AT LEAST 2100mm BELOW NATURAL GRADE LINE UNLESS OTHERWISE INDICATED IN PLANS. NO FOOTING SHALL REST ON FILL.
- 3. MINIMUM CONCRETE PROTECTION FOR REINFORCEMENTS SHALL BE 75mm CLEAR FOR CONCRETE DEPOSITED THE GROUND AND 50mm FOR CONCRETE DEPOSITED AGAINST A FORMWORK

NOTES ON REINFORCEMENT

- UNLESS OTHERWISE NOTED IN PLANS, THE YIELD STRENGTH OF REINFORCING BARS SHALL BE: A. FOOTINGS, FOOTING BEAMS AND GIRDERS ----fy = 414 MPa (60,000 psi)
- fy = 414 MPa (60,000 psi) B. COLUMNS AND SHEAR WALLS ----fy = 414 MPa (60,000 psi) C. BEAMS AND GIRDER
- D. NON-LOAD BEARING WALL PARTITIONS, BEDDED SLABS, FLOOR & ROOF SLABS, PARAPETS, CATCH BASIN, SIDE WALK. -----fy = 275MPa (40,000 psi)
- 2. ALL REINFORCING BARS SIZE 10mm OR BIGGER SHALL BE DEFORMED IN ACCORDANCE WITH ASTM A 706. BARS SMALLER THAN 10mm MAY BE PLAIN.
- 3. SPLICES SHALL BE SECURELY WIRED TOGETHER & SHALL LAP OR EXTEND IN ACCORDANCE W/ TABLE A & TABLE B (TABLE OF LAP SPLICE & ANCHORAGE LENGTH) UNLESS OTHERWISE SHOWN ON DRAWINGS, SPLICES SHALL BE STAGGERED WHENEVER POSSIBLE.

NOTES ON CONCRETE SLABS

- 1. ALL SLAB REINFORCEMENTS SHALL BE 20mm CLEAR MINIMUM FROM BOTTOM AND FROM THE TOP OF SLAB.
- 2. UNLESS OTHERWISE DETAILED IN CONTINUOUS SLAB HAVING SAME REINFORCEMENT RUNNING IN ONE DIRECTION, REINFORCING BARS SHALL BE BENT UP, OR CUT AS FOLLOWS

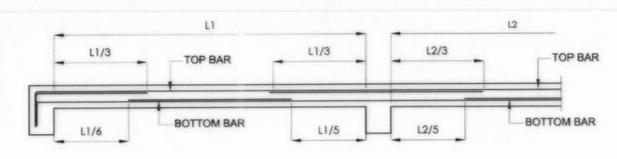

TYPICAL BAR BENDING AND CUTTING DETAILS FOR SLABS


- 3. IF SLABS ARE REINFORCED BOTHWAYS BARS ALONG THE SHORTER SPAN SHALL BE PLACED BELOW THOSE ALONG THE LONG SPAN AT THE CENTER AND OVER THE LONGER SPAN FOR REINFOCING BARS NEAR THE SUPPORTS. THE SPACING OF THE BARS AT THE COLUMN STRIPS SHALL BE APPOXIMATELY ONE AND A HALF (1 1/2) SLAB THICKNESS OR 45 CENTIMETERS
- 4. TEMPERATURE BARS FOR SLAB SHALL BE GENERALLY PLACED NEAR THE FACE IN TENSION AND SHALL NOT BE LESS THAN 0.0025 BT. (SEE SCHEDULE BELOW)

SCHEDULE (OF MINIMUM SLAB REINFORCEMENT
THICKNESS	MINIMUM TEMPERATURE BARS
100 mm	10 mm Ø @ 300mm EACH WAY
125 mm	10 mm Ø @ 250mm EACH WAY
150 mm	10 mm Ø @ 200mm EACH WAY
175 mm	10 mm Ø @ 175mm EACH WAY
200 mm	10 mm Ø @ 150mm EACH WAY

- 5. UNLESS OTHERWISE NOTED IN THE PLANS ALL BEDDED SLABS SHALL BE REINFORCED WITH 10mm Ø AT 250mm O.C EACH WAY TO CENTER OF SLAB AND CONSTRUCTION JOINTS FOR SAME SHALL NOT BE LESS THAN 3.65 METER APART
- 6. PROVIDE EXTRA REINFORCEMENTS FOR CORNER SLAB (TWO ADJACENT DISCONTINUOUS EDGES) AS SHOWN BELOW.

TYPICAL CORNER SLAB DETAIL

7. CONCRETE SLAB REINFORCEMENTS SHALL BE PROPERLY SUPPORTED WITH 10mmØ STEEL CHAIR OR APPROVED EQUIVALENT SPACED AT 1.0 METER ON CENTER BOTHWAYS

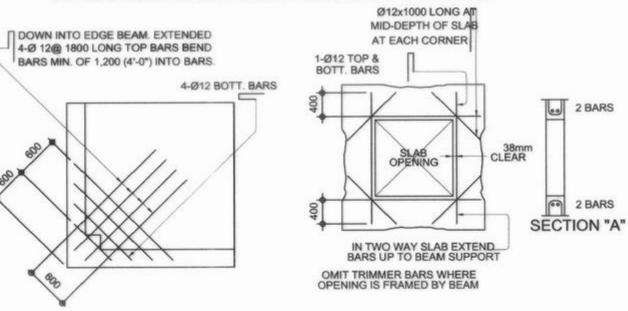


TYPICAL SLAB OPENING DET.

VISITACION Q. MENDOZA

DIRECTOR IV - REGIONAL DIRECTOR

NOTES ON COLUMNS


- 1. PROVIDE EXTRA SETS OF TIES AT 100mm O.C. FOR TIED COLUMN REINFORCEMENT ABOVE AND BELOW BEAM-COLUMN CONNECTIONS FOR A DISTANCE FROM FACE OF CONNECTION EQUAL TO THE GREATER OF THE OVERALL THICKNESS OF COLUMN, 1/6 THE CLEAR HEIGHT OF COLUMN OR 450mm.
- 2. COLUMN TIES SHALL BE PROTECTED EVERYWHERE BY A COVERING OF CONCRETE CAST MONOLITHICALLY WITH THE CORE WITH THE MINIMUM THICKNESS OF 40mm AND NOT LESS THAN 40 TIMES THE MAXIMUM SIZE OF COARSE AGGREGATE IN MILLIMETERS.
- 3. WHERE COLUMNS CHANGE IN SIZE, VERTICAL REINFORCEMENTS SHALL SHALL BE OFFSET AT A SLOPE OF NOT MORE THAN 1 IN 6 AND EXTRA 10mm TIES AT 100mm SHALL BE PROVIDED THRU OUT THE OFFSET REGION.
- 4. UNLESS OTHERWISE INDICATED IN THE PLANS, LAP SPLICES FOR COLUMN REINFORCE-MENT SHALL BE MADE WITHIN THE CENTER HALF OF COLUMN HEIGHT, AND THE SPLICE LENGTH SHALL NOT BE LESS THAN 40 BAR DIAMETERS. WELDING OR APPROVED MECHANICAL DEVICES MAY BE USED PROVIDED THAT NOT MORE THAN ALTERNATE BARS EMBEDMENT ARE WELDED OR MECHANICALLY SPLICED AT ANY LEVEL AND THE VERTICAL DISTANCES BETWEEN THESE WELDS OR SPLICES OF ADJACENT BARS IS NOT LESS THAN 600mm.

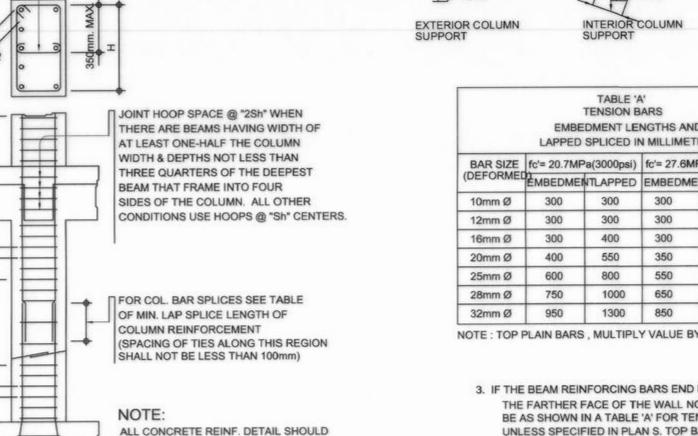

TYPICAL COLUMN ELEV. SHOWING DOWELS AND TIES SPACING

BE DONE IN ACCORDANCE WITH ACI

DETAILING MANUAL LATEST EDITION

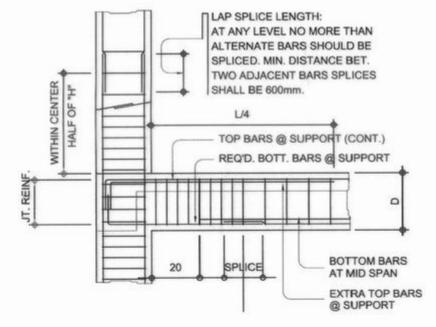

TYP. DETAIL OF COL. LAP SPLICE & EXT. GIRDER TO COL. CONNECT.


AMELIA P. VALDEZ

RECTOR IV - GENERAL SERVICES OFFICE

SUBMITTED:

NOTES ON BEAMS AND GIRDERS

- 1. UNLESS, OTHERWISE NOTED IN PLANS, CAMBER ALL BEAMS AND GIDER AT LEAST 6mm.S FOR EVERY 4.50M OF SPAN , EXCEPT CANTILEVERS FOR WHICH THE CAMBER SHALL BE AS NOTED IN PLANS OR AS ORDERED BY THE ENGINEER BUT IN NO CASE LESS THAN 20mm FOR EVERY 3.0M OF FREE SPAN
- 2. TYPICAL BARS BENDING AND CUTTING DETAILS FOR BEAMS SHALL BE AS SHOWN IN FIG. B-1.

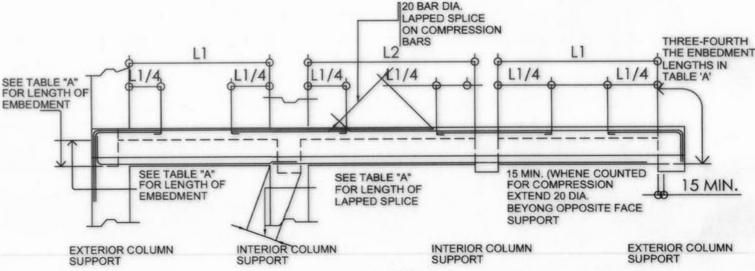


						EMBED	TABLE 'B' IPRESSION MENT LEN SPLICED IN		RS
BAR SIZE	fc'= 20.7MF	a(3000psi)	fc'= 27.6MF	Pa(4000psi)	BAR SIZE	fc'= 20.7MF	Pa(3000psi)	fc'= 27.6M	Pa(4000ps
(DEFORME	EMBEDME	NTLAPPED	EMBEDME	NTLAPPED	(DEFORMED	EMBEDME	NTLAPPED	EMBEDME	NTLAPPE
10mm Ø	300	300	300	300	10mm Ø	225	300	200	300
12mm Ø	300	300	300	300	12mm Ø	275	300	250	300
16mm Ø	300	400	300	400	16mm Ø	350	400	325	400
20mm Ø	400	550	350	500	20mm Ø	450	500	475	500
25mm Ø	600	800	550	750	25mm Ø	550	625	550	625
28mm Ø	750	1000	650	850	28mm Ø	625	675	625	675
32mm Ø	950	1300	850	1100	32mm Ø	700	775	700	775

FIG. B-1

NOTE: TOP PLAIN BARS, MULTIPLY VALUE BY 2

NOTE: TOP PLAIN BARS, MULTIPLY VALUE BY 2 VALUES GIVEN ABOVE CAN ALSO BE USED

- 3. IF THE BEAM REINFORCING BARS END IN A WALL THE CLEAR DISTANCE FROM THE BAR TO THE FARTHER FACE OF THE WALL NOT BE LESS THAN 25mm. EMBEDMENT LENGTH SHALL BE AS SHOWN IN A TABLE 'A' FOR TENSION BARS AND TABLE 'B' FOR COMPRESSION BARS UNLESS SPECIFIED IN PLAN S. TOP BAR SHALL NOT BE SPLICED WITHIN THE COLUMN OR WITHIN A DISTANCE TWICE THE MEMBER DEPTH FROM THE FACE OF THE COLUMN. AT LEAST TWO STIRRUPS SHALL BE PROVIDED AT ALL SPLICES.
- 4. IF THERE ARE TWO OR MORE LAYERS OF REINFORCING BARS, USE 25mmØ BAR SEPARATORS SPACED AT 1.0M ON CENTER. IN NO CASE SHALL THERE BE LESS THAN TWO (2) SEPARATORS BETWEEN TWO LAYERS OF BARS.
- 5. MINIMUM CONCRETE PROTECTION FOR REINFORCING BARS OR STEEL SHAPES SHALL BE AS SHOWN IN FIG. B-2 UNLESS SPECIFIED ELSEWHERE.

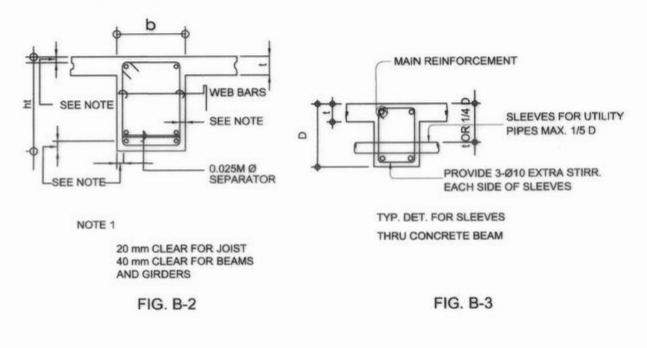

6. WHEN A BEAM CROSSES A GIRDER, REST BEAM ON TOP OF GIRDER BARS, BEAM REINF-FORCING BAR SHALL BE SYMMETRICAL ABOUT CENTER LINE WHENEVER POSSIBLE.

APPROVED (BY THE AUTORITY OF THE CHAIRPERSON)

7. GENERALLY NO SPLICES SHALL BE PERMITTED AT POINTS WHERE CRITICAL BENDING STRESSES OCCUR, SPLICES WHERE SO PERMITTED SHALL BE INDICATED IN THE TABLE 'A' AND 'B'. WELDED SPLICES SHALL DEVELOP IN TENSION AT LEAST 125 % OF THE SPECIFIED YIELD STRENGTH OF THE BAR. NOT MORE THAN 50% OF THE BARS AT ANY ONE SECTION IS ALLOWED TO BE SPLICED THEREIN.



REPUBLIC OF THE PHILIPPINES

REGIONAL OFFICE IX

/ETERANS AVENUE EXT., TETUAN, ZAMBOANGA CITY

REPUBLIC OF THE PHILIPPINES COMMISSION ON AUDIT REGIONAL OFFICE NO. IX CABATANGAN, ZAMBOANGA CITY

PROJECT & LOCATION: MENT OF PUBLIC WORKS AND HIGHWAYS

COA REGIONAL OFFICE NO. IX TRAINING CENTER AND **DORMITORY BUILDING** CABATANGAN, ZAMBOANGA CITY

SHEET CONTENT: PREPARED: **GENERAL CONSTRUCTION NOTES**

RECOMMENDING APPROVAL:


PIO MARIO T. LACASTESANTOS CHIEF, BRIDGE A OTHER PUBLIC WORKS DESIGN SECTION

REVIEWED:


SATURNINO C. TORREFRANCA DISTRICT ENGINEER OIC - CHIEF, PLANNING & DESIGN DIVISION

KHADAFFY D. TANGGOL

RECOMMENDED: APPROVED: CAYAMOMBAO D. DIA, CESO IV

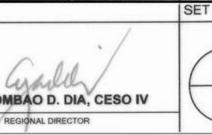

LORNA D. CABOCHAN

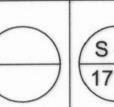

SHEET NO.

GENERAL CONSTRUCTION NOTES


NOTES ON CONCRETE HOLLOW BLOCK WALLS


- 1. UNLESS OTHERWISE SHOWN IN PLANS ALL CONCRETE HOLLOW BLOCKS AND CERAMIC BLOCKS SHALL BE REINFORCED AS SHOWN IN THE SCHEDULE OF CONCRETE HOLLOW BLOCKS AND CERAMIC BLOCK REINFORCEMENT.
- 2. PROVIDE 150mm x 300mm STIFFENER COLUMN REIFORCED WITH 4-12mm WITH 10mmØ TIES AT 150mm ON CENTER WHERE CONCRETE HOLLOW BLOCK TERMINATES AND AT EVERY 3.0M LENGTH OF CONCRETE HOLLOW BLOCK WALLS UNLESS NOTED IN STRUCTURAL PLANS.

BLOCK THICKNESS	REINFOR	CEMENT	NOTES			
	HORIZONTAL	VERTICAL	A. MINIMUM LAPS AT SPLICE = 0.25M			
75 mm	10mmØ @ 600mm O.C.	10mmØ @ 600mm O.C.	B. PROVIDE RIGHT ANGLED REINFORCEMEN AT CORNERS 0.92M LONG			
125 mm	10mmØ @ 600mm O.C.	10mmØ @ 600mm O.C.	C. WHERE CHB OR CER. BLK. WALL DOWELS JOIN COL. R.C. BEAMS AND WALL DOWE			
150 mm	10mmØ @ 600mm O.C.	10mmØ @ 600mm O.C.	WITH THE SAME SIZE AS VERT. OR HOR.			
200 mm	12mmØ @ 600mm O.C.	12mmØ @ 600mm O.C.	REINFORCEMENTS SHALL BE PROVIDED			

REINFORCING CONCRETE LINTEL BEAM IN CONCRETE BLOCK WALLS

		LIN	TELS IN	BLOCK	WAL	LS	
CLEAR SPAN ("L")	El Company of the Com	MIN.	HEIGHT O	F REINFORCEMENT			
	(L+0.40M)	HOLDER (1997)	(MM)	воттом	TOP	STIRRUPS	
1.20M	1.60M		200	1-Ø10	1-Ø10	Ø6mm @ 200mm	
150M	1.90M	14.0	200	1-Ø10	1-Ø10	Ø6mm @ 200mm	
1.80M	2.20M		200	1-Ø12	1-Ø10	Ø6mm @ 200mm	
2.10M	2.50M	No.	250	1-Ø12	1-Ø10	Ø6mm @ 200mm	
2.40M	2.90M	17.0	250	1-Ø12	1-Ø10	Ø6mm @ 200mm	
2.70M	3.10M		250	1-Ø16	1-Ø12	Ø10mm @ 200mm	
3.00	3.40M		300	1-Ø16	1-Ø12	Ø10mm @ 200mm	
3.30	3.70M	20.0	300	1-Ø16	1-Ø12	Ø10mm @ 200mm	
3.60	4.00	0.0000000000000000000000000000000000000	300	1-Ø20	1-Ø12	Ø10mm @ 200mm	

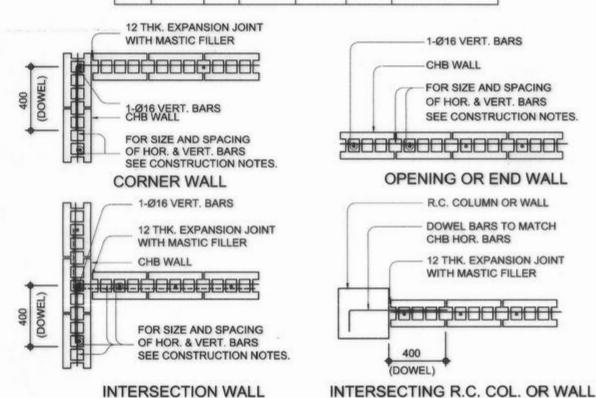


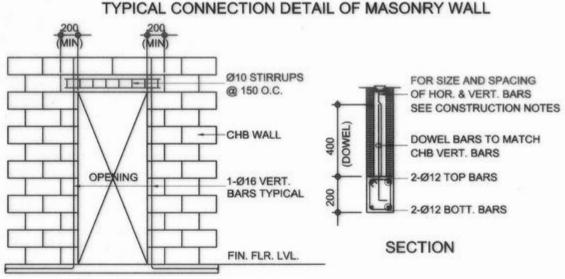



ELEVATION TYP. DET. OF LINTEL BEAM AT CHB WALL OPENING

DOWEL BARS TO ALL JOINTS AND CELLS CONTAINING REINFORCING BARS SHALL BE FILLED WITH CONCRETE GROUT. 2. FOR REINFORCEMENTS SEE CONSTRUCTION NOTES. 1-Ø16 CONT. HOR. BARS FOR FLOOR SLAB ONLY


TYP. SECTION OF MASONRY PARTITION REINFORCEMENTS

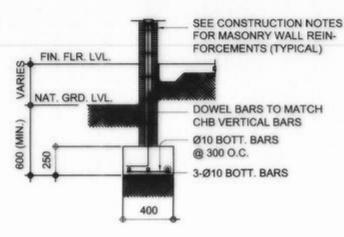

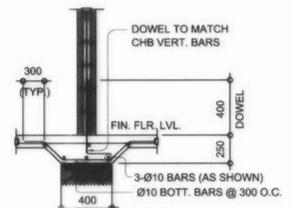

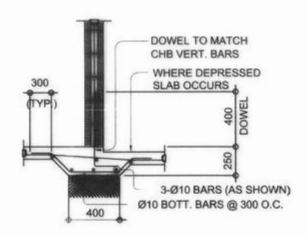

TYPICAL CHB FOOTING DETAILS (WHERE APPLICABLE)

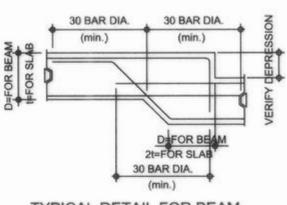

TYPICAL DETAIL FOR BEAM OR SLAB CHANGE SOFFIT

SHEET CONTENT:


NOTES ON CONCRETE WALLS

1. ALL WALLS SHALL BE REINFORCED ACCORDING TO THE FOLLOWING SCHEDULE OF WALL REINFORCEMENT UNLESS OTHERWISE INDICATED IN THE PLANS.

WALL	REINFO	VERTICAL			
	HORIZONTAL	VERTICAL	REMARKS	SECTION	
100mm 125mm 150mm	Ø10mm @ 200mm O.C.		HORIZONTAL BARS AT CENTERS VERTICAL BARS STAGGERED OUT	VERT. BARS HORIZ BARS	

REINFORCING BARS SHALL HAVE 25mm CLEAR CONCRETE COVER FROM FACE OF WALL EXCEPT FOR WALLS IN CONTACT WITH THE GROUND WHERE A MINIMUM OF 60mm SHALL BE PROVIDED, AND FOR EXPOSED FACES OF FORMED WALLS WHERE THE MINIMUM SHALL BE 50mm CLEAR.

- 2. CARRY VERTICAL BARS AT LEAST 60mm ABOVE FLOOR LEVEL TO PROVIDE FOR SPLICES WHEN NECESSARY STOP AT 50mm BELOW TOP SLAB OR SOLID BAND WHERE THE WALL ENDS VERTICAL AND HORIZONTAL BARS SHALL BE SPLICED BY LAPPING A DISTANCE EQUAL TO 30 DIAMETERS AND WIRED SECURELY WITH 16 G.I. WIRE PROVIDED THAT SPLICES IN ADJACENT BARS ARE STAGGERED AT LEAST 1.50M.O.C.
- 3. UNLESS OTHERWISE NOTED IN THE PLANS, ALL OPENINGS IN WALLS 250mm OR THICKER SHALL BE REINFORCED AROUND WITH 2-20mmØ BARS FOR 225mm, 200mm, 175mm, 150mm, USE 2-16mmØ, FOR 125mm AND 100mm WALLS, USE 2-12mmØ BARS. ALL WALLS SPANNING SHALL HAVE VERTICAL REINFORCEMENT BENT TO A U-FORM LIKE STIRRUPS AND SPACED ACCORDING TO THE SCHEDULE UNLESS OTHERWISE NOTED (SEE FIG.1)

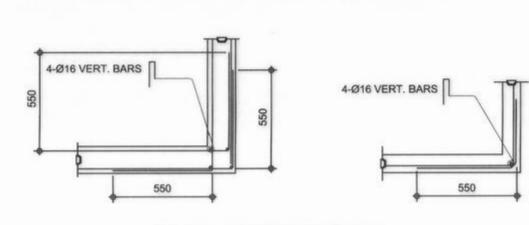

TYPICAL CONNECTION DETAIL OF R.C. WALL AT CORNERS

NOTES ON WELDS

- 1. USE E70xx ELECTRODES FOR ALL MEMBERS WELDED.
- 2. WELDS SHALL DEVELOP THE FULL STRENGTH OF MEMBERS JOINED UNLESS OTHERWISE SHOWN OR DETAILED IN THE DRAWINGS.

NOTES ON STRUCTURAL STEEL


- 1. STRUCTURAL STEEL TO BE USED FOR FABRICATION AND ERECTION OF THIS STRUCTURE SHALL COMPLY WITH ALL THE PERTINENT PROVISION OF AISC SPECIFICATION FOR THE DESIGN, FABRICATION AND ERECTION OF STRUCTURAL STEEL FOR BUILDING LATEST EDITION.
- 2. ALL STRUCTURAL STEEL SHAPES SHALL BE ASTM A 36 STRUCTURAL STEEL UNLESS OTHERWISE INDICATED.
- 3. ALL WELDED CONNECTIONS SHALL DEVELOP THE FULL STRENGTH OF THE MEMBERS CONNECTED.
- ALL BOLTS USED UNLESS OTHERWISE SPECIFIED SHALL BE ASTM A 307 BOLTS.

NOTES ON EMBEDED PIPES


- A. ALL EMBEDED PIPES FOR UTILITIES, ETC. THAT PASS THRU BEAMS SHALL BE MAXIMUM 100mm OR D/3 WHICHEVER IS LESS DIAMETER SINGLE RIGID GALVANIZED IRON PIPE UNLESS OTHERWISE OR APPROVED IN WRITING BY THE STRUCTURAL ENGINEER.
- B. NO PIPES SHALL BE ALLOWED TO PASS THRU BEAMS VERTICALLY.
- C. NO PIPES SHALL BE EMBEDED TO COLUMNS.

NOTES ON CONCRETE HOLLOW BLOCK WALLS

1. WHERE A CONSTRUCTION JOINT IS TO BE MADE, THE SURFACE OF CONCRETE SHALL BE CLEANED AND ALL LAITANCE AND STANDING WATER REMOVED. SHEAR KEY SHALL BE PROVIDED AT THE JOINT.

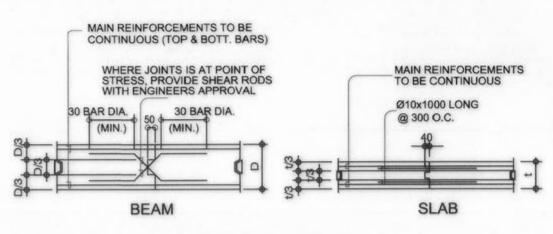


TYPICAL SLAB & BEAM CONSTRUCTION JOINT DET.

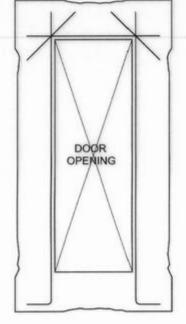

PROVIDE THESE ADDITIONAL BARS FOR ALL OPENINGS PLUS BARS (NOT SHOWN) PARALLEL TO SIDE OF OPENING EQUAL TO THE NUMBER OF TERMINATED BARS AT OPENING


SEE ARCHITECTURAL & MECHANICAL PLANS FOR SLAB OPENING LOCATION.

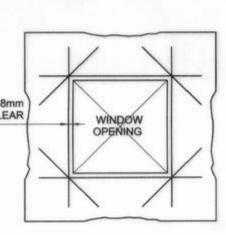

TYP. EXTERIOR WINDOW & DOOR OPENING

NOTES OF STIRRUPS

- 1. ALL REINFORCEMENT SHALL BE BENT COLD UNLESS OTHERWISE PERMITTED BY THE STRUCTURAL ENGINEER.
- 2. REINFORCEMENT PARCIALLY EMBEDED IN CONCRETE SHALL NOT BE FILLED BENT, EXCEPT AS SHOWN IN THE DESIGN DRAWINGS OR PERMITTED BY THE STRUCTURAL ENGINEER.
- 3. TIES & CLOSE STIRRUPS MUST BE BENT AT 135°.

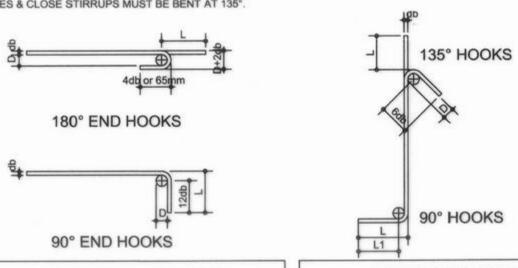

	MAIN BA (ALL	R END GRAD		(S
BAR SIZE (DEFORMED	DIAMETER	180° I	ноок	90° HOOK
	(mm)	D+2db	L	L
10mm Ø	60	75	125	150
12mm Ø	75	100	150	200
16mm Ø	95	125	175	250
20mm Ø	115	150	200	300
25mm Ø	150	200	230	450
28mm Ø	240	300	350	550
32mm Ø	300	335	450	600

	(ALI	L GRAD	DES)	
BAR SIZE	DIAMETER	180° H	ЮОК	90° HOOK
DEFORMED)	(mm)	D+2db	L	L
10mm Ø	40	125	85	100
12mm Ø	50	165	115	115
16mm Ø	65	200	140	150
20mm Ø	115	250	165	300
25mm Ø	150	365	230	405



REPUBLIC OF THE PHILIPPINES COMMISSION ON AUDIT **REGIONAL OFFICE NO. IX**

PROJECT & LOCATION:

CABATANGAN, ZAMBOANGA CITY

RECOMMENDING APPROVAL:

VISITACION Q. MENDOZA **DIRECTOR IV - REGIONAL DIRECTOR**

AMELIA P. VALDEZ RECTOR IV - GENERAL SERVICES OFFICE APPROVED (BY THE AUTORITY OF THE CHAIRPERSON)

LORNA D. CABOCHAN

REPUBLIC OF THE PHILIPPINES MENT OF PUBLIC WORKS AND HIGHWAYS REGIONAL OFFICE IX VETERANS AVENUE EXT., TETUAN, ZAMBOANGA CITY

COA REGIONAL OFFICE NO. IX TRAINING CENTER AND DORMITORY BUILDING CABATANGAN, ZAMBOANGA CITY

GENERAL CONSTRUCTION NOTES JULMALI A. AHIYAL STERED CIVIL ENGINEER

PIO MARIO T LACASTESANTOS CHIEF, BRIDGE & STHER PUBLIC WORKS DESIGN SECTION

REVIEWED:

SATURNINO/C. TORREFRANCA DISTRICT ENGINEER

SUBMITTED:


OIC - CHIEF, PLANNING & DESIGN DIVISION

KHADAFFY D. TANGGOL

RECOMMENDED:


CAYAMOMBAO D. DIA, CESO IV

APPROVED:

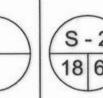



SHEET NO.:

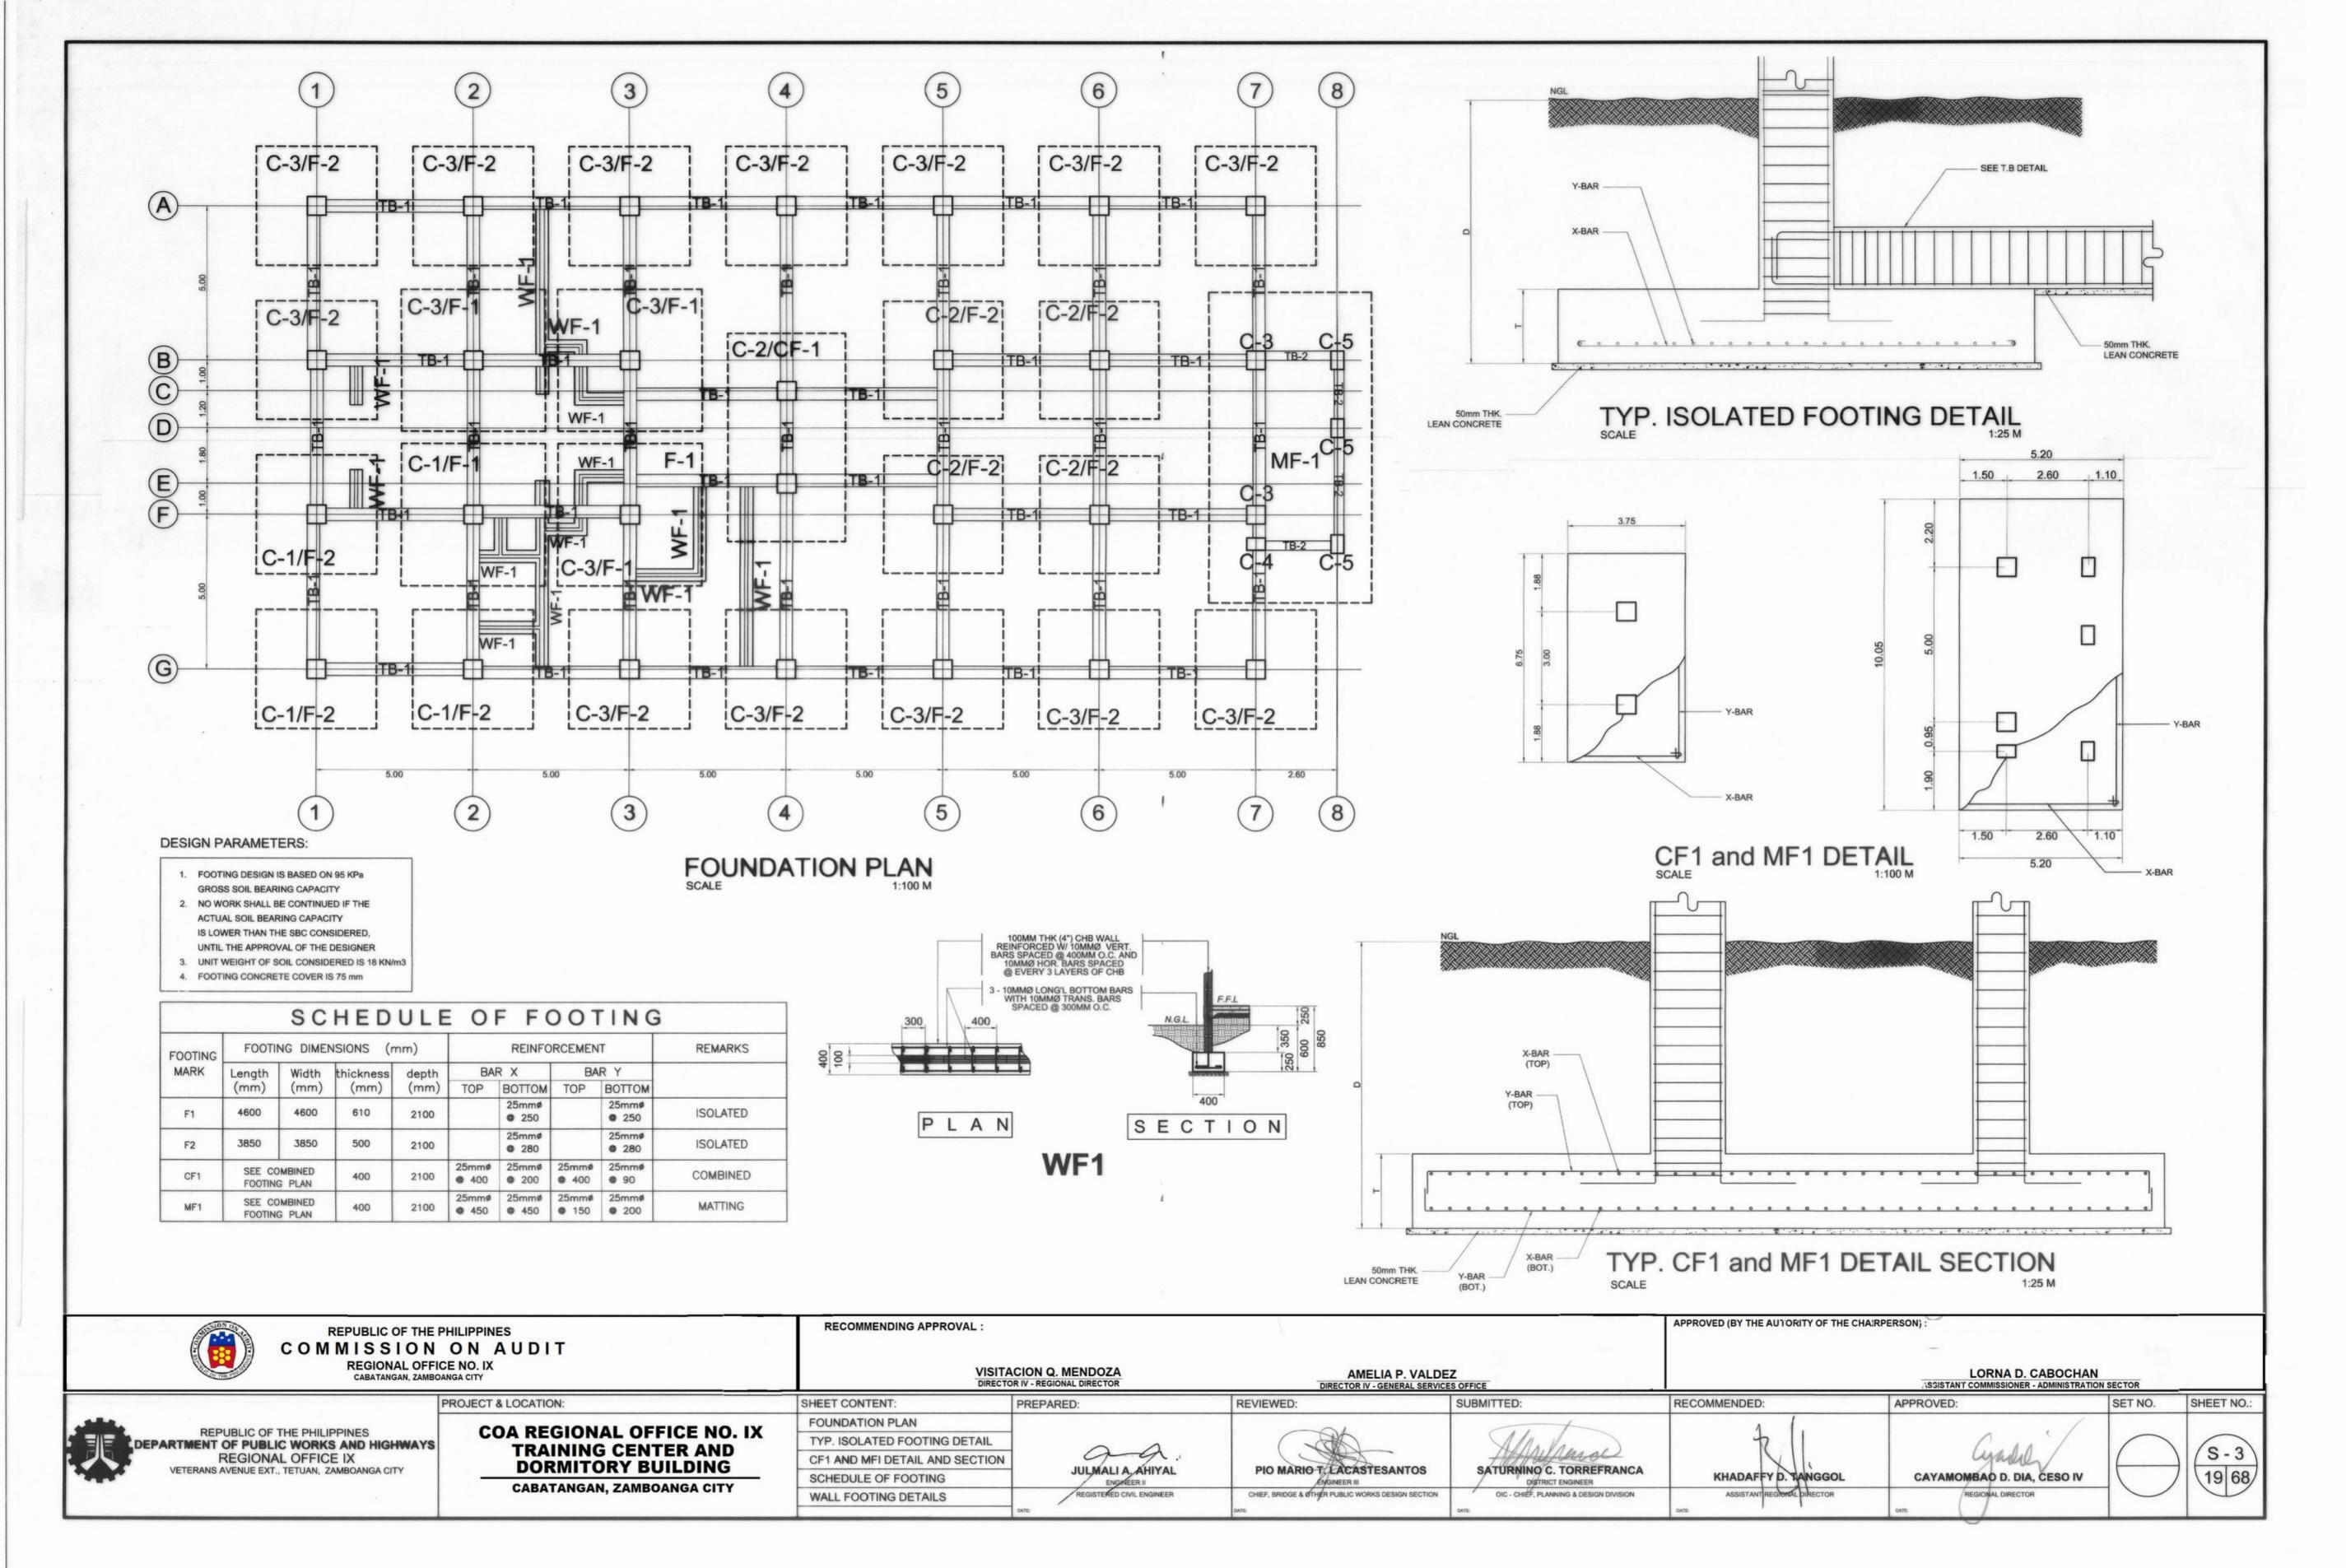

LEVEL			COLUMN	SCHEDULE		
LVLL		C1	C2	С3	C4	C5
RD TO ROOF						
	SIZE MAIN BAR TIES (L) END REGION	600x600 20-25mm¢ 12mm¢ • 150 - 3 SETS 12mm¢ • 100 - 3 SETS	C2 is just until 3F FLR LN	C2 is just until RD FLR LN	C3 is just until RD FLR LN	C4 is just until RD FLR
3F TO RD						
	SIZE MAIN BAR TIES (L) END REGION	600x600 20-25mmø 12mmø @ 150 - 3 SETS 12mmø @ 100 - 3 SETS	C2 is just until 3F FLR LN	600x600 20-25mmø 10mmø @ 150 - 3 SETS 10mmø @ 100 - 3 SETS	600x400 12-20mmø 10mmø • 150 - 3 SETS 10mmø • 100 - 3 SETS	10mmø 100 - 3 SET
2F TO 3F						
	SIZE MAIN BAR TIES (L) END REGION	600x600 20-25mmø 12mmø @ 150 - 3 SETS 12mmø @ 100 - 3 SETS	600x600 20-20mmø 10mmø Ø 150 - 3 SETS 10mmø Ø 100 - 3 SETS	600×600 20-25mm# 10mm# • 150 - 3 SETS 10mm# • 100 - 3 SETS	600x400 12-20mmø 10mmø @ 150 - 3 SETS 10mmø @ 100 - 3 SETS	600x600 12-20mmø 10mmø 6 150 - 3 SET 10mmø 6 100 - 3 SET
GF TO 2F						
	SIZE MAIN BAR TIES (L) END REGION	600x600 20-25mm# 12mm# @ 150 - 3 SETS 12mm# @ 100 - 3 SETS	600x600 20-20mmø 10mmø @ 150 - 3 SETS 10mmø @ 100 - 3 SETS	600x600 20-25mm¢ 10mm¢ • 150 - 3 SETS 10mm¢ • 100 - 3 SETS	600x400 12-20mm¢ 10mm¢ • 150 - 3 SETS 10mm¢ • 100 - 3 SETS	400x600 12-20mm 10mm# @ 150 - 3 SET 10mm# @ 100 - 3 SET
FDN TO GF						
	SIZE MAIN BAR TIES (L) END REGION	600x600 20-25mmø 12mmø @ 150 - 3 SETS 12mmø @ 100 - 3 SETS	600x600 20-20mmø 10mmø @ 150 - 3 SETS 10mmø @ 100 - 3 SETS	600×600 20-25mm¢ 10mm¢ © 150 - 3 SETS 10mm¢ © 100 - 3 SETS	600x400 12-20mmø 10mmø @ 150 - 3 SETS 10mmø @ 100 - 3 SETS	400×600 12-20mm 10mmø @ 150 - 3 SET 10mmø @ 100 - 3 SET

					S	CHED	JLE	OF TIE	BE	AMS		
FLOOR	BEAM MARK	1.7532545.000	EAM NSIONS	STE	ELR	EINFO	RCE	MENTS			STIRRUPS	
		(in/m	The second second	REBAR	LEF	т	MIC	SPAN	RI	GHT		
		b	d	(mm Ø)	TOP	воттом	TOP	воттом	TOP	воттом	TOTTILLO BELLEO	
	TB-1	400	600	Ø20mm	12	6	6	6	12	6	SPACED 1 @ 50, 6 @ 100, & REST 150 UP TO 1	
5	TB-2	300	500	Ø20mm	8	4	4	4	8	4		

^{*16}mmØ or Bigger- USE GRADE 60 (414 MPa)

^{*12}mmØ or Smaller- USE GRADE 40 (275 MPa)



REPUBLIC OF THE PHILIPPINES COMMISSION ON AUDIT REGIONAL OFFICE NO. IX CABATANGAN, ZAMBOANGA CITY

PROJECT & LOCATION:

RECOMMENDING APPROVAL:

VISITACION Q. MENDOZA DIRECTOR IV - REGIONAL DIRECTOR AMELIA P. VALDEZ
DIRECTOR IV - GENERAL SERVICES OFFICE

TENSION LAP SPLICE ONLY WITHIN CENTER HALF OF THE CLEAR COLUMN HEIGHT (H)

APPROVED (BY THE AUTORITY OF THE CHAIRPERSON)

LORNA D. CABOCHAN
ASSISTANT COMMISSIONER - ADMINISTRATION SECTOR

REPUBLIC OF THE PHILIPPINES DEPARTMENT OF PUBLIC WORKS AND HIGHWAYS
REGIONAL OFFICE IX
VETERANS AVENUE EXT., TETUAN, ZAMBOANGA CITY

COA REGIONAL OFFICE NO. IX TRAINING CENTER AND **DORMITORY BUILDING** CABATANGAN, ZAMBOANGA CITY


JULMALI A. AHIYAL REGISTERED CIVIL ENGINEER


PIO MARIO T. LACASTESANTOS CHIEF, BRIDGE & OTHER PUBLIC WORKS DESIGN SECTION SATURNING C. TORREFRANCA DISTRICT ENGINEER OIC - CHIEF, PLANNING & DESIGN DIVISION

RECOMMENDED: ASSISTANT REGION DIRECTOR

CAYAMOMBAO D. DIA, CESO IV REGIONAL DIRECTOR

APPROVED:

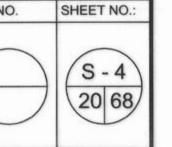

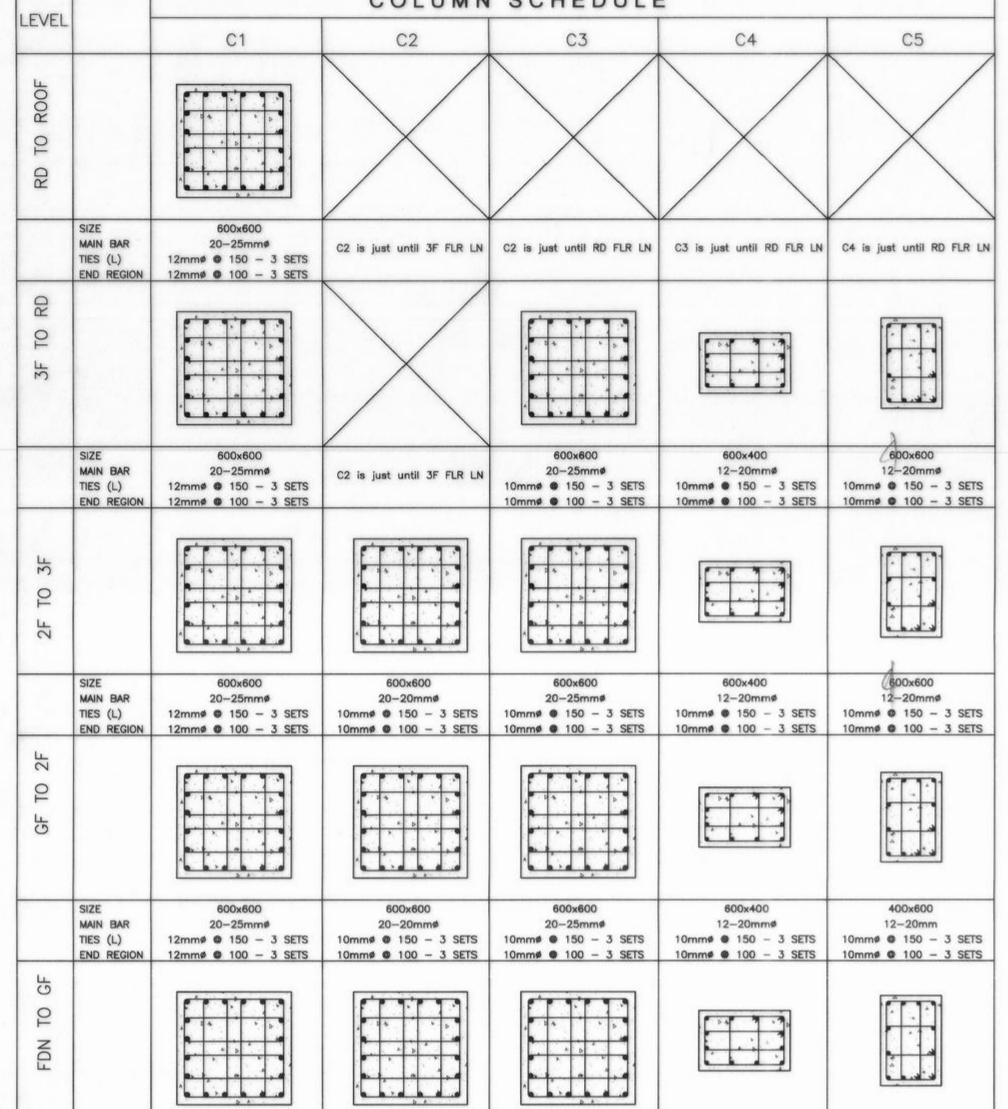

NOTES:

HOOP & SUPPLEMENTARY CROSSTIE SPACING NOT TO

OFFSET VERTICAL BAR 1:6 SLOPE MAXIMUM

NOTE:

THE CONTRACTOR SHALL NOTIFY THE

HAS BEEN COMPLETED, TO CONFIRM THE DESIGN SOIL BEARING CAPACITY.

UPON CONFIRMATION OF THE ACTUAL

JOINT HOOPS MUST BE SPACED @ 2Sh FOR THE DEPTH OF THE SHALLOWEST BEAM WHEN BEAMS WITH GREATER THAN 3/4 TIMES THE WIDTH OF THE COLUMN FRAME INTO THE FOUR SIDES OF A COLUMN. FOR ALL OTHER CONDITIONS,

USE HOOPS SPACED @ "Sh" ON CENTER

SOIL BEARING CAPACITY.

ENGINEER AFTER FOOTING EXCAVATION

FOOTING AND COLUMN TO BE ADJUSTED

EXCEED Bs/4 or 100mm. COLUMN TIE SPACING, NOT TO EXCEED 16db OF VERTICALS,


48db OF TIES, Bs or 150mm, WHICHEVER IS LESSER SMALLER DIMENSION OF COLUMN CROSS SECTION Bs =


LARGEST COLUMN DIMENSION, 6 OF CLEAR HEIGHT OR 450mm,

WHICHEVER IS GREATER CLEAR HEIGHT OF COLUMN

SUBMITTED:

SHEET CONTENT: REVIEWED: PREPARED: COLUMN SCHEDULE TIE BEAM SCHEDULE

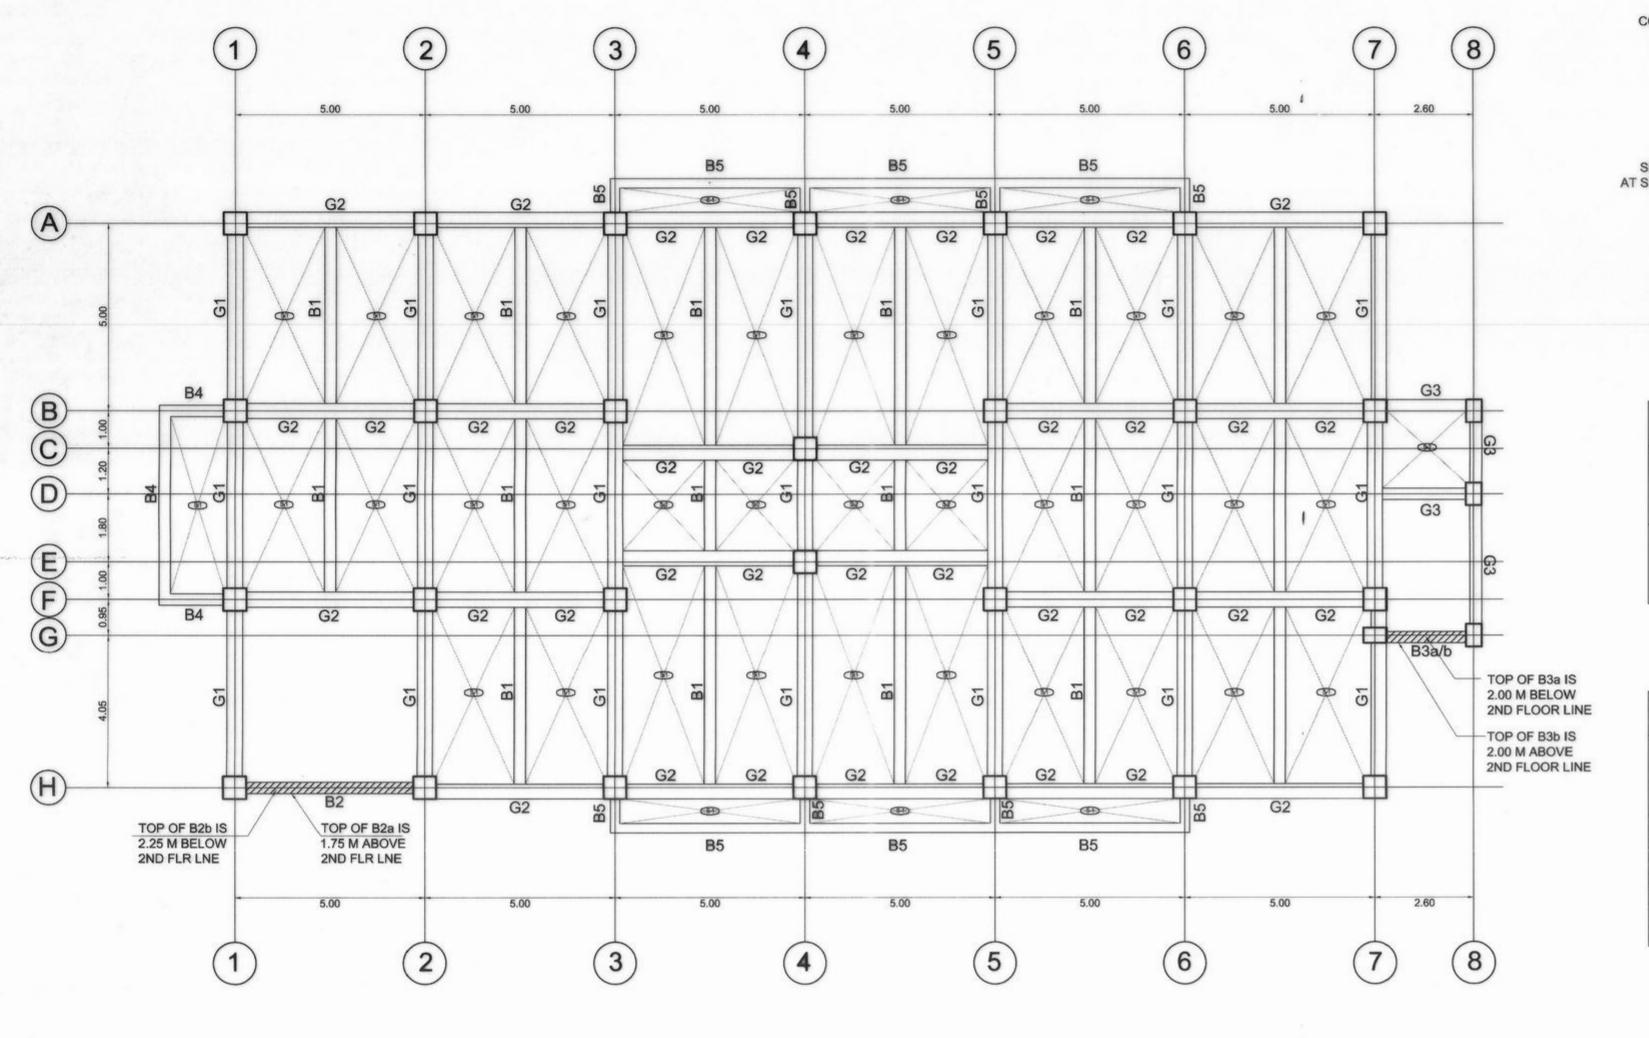

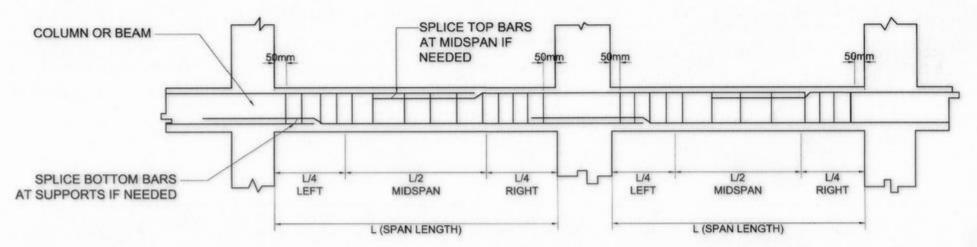

TYPICAL BEAM ELEVATION NTS

				S	CHEC	DULE C	OF M	AIN BE	EAMS	S			
		5 - Carlo Co. 1 - 1 - 1 - 1 - 1 - 1 - 1 - 1 - 1 - 1	EAM		ST	EELR	EINF	ORCEN	1 E N T	s		STIRR	UPS
FLOOR LEVEL	BEAM MARK	(in/m	NSIONS m)	REBAR	LEF	т	MIC	SPAN	RI	GHT	STIFFENER		
	200000000000000000000000000000000000000	В	D	(mm Ø)	TOP	воттом	TOP	воттом	TOP	воттом	BARS		
	G-1	400	550	Ø20mm	10	5	5	5	10	5		3	@5O, 3 @75,
3	G-2	400	550	Ø20mm	12	6	6	6	12	6	2 - 12mm Ø	A	@ 100, REST AT
2F	G-3	300	450	Ø20mm	6	3	3	3	6	3		1	150 TO &

			S	CHED	JLE (OF SE	CON	DARY	BEA	MS		
		7500	EAM		S	TEEL R	EINF	ORCEN	MENT	s		STIRRUPS
FLOOR	BEAM MARK	(in/m	NSIONS m)	REBAR	LEF	т	MID	SPAN	RI	GHT	STIFFENER	
	11.7500/2500/9865	В	D	(mm Ø)	TOP	воттом	TOP	воттом	TOP	воттом	BARS	
	B-1	300	450	Ø20mm	7	5	5	5	7	5		
3	B-2a/b	300	450	Ø20mm	5	4	4	4	5	4		10mmØ: 1 @50, 3 @75,
FLR	B-3a/b	300	450	Ø20mm	5	4	4	4	5	4	2 - 12mm Ø	6 @ 100, REST AT
2ND	B-4	300	450	Ø20mm	6	3	3	6	5	3		150 TO €
2	B-5	250	400	Ø20mm	4	2	2	2	4	2		

SECOND FLOOR FRAMING PLAN 1:100 M

	SCHEDULE OF SLABS																
T				Д	LONG SH	ORT DI	RECTION					ALONG LO	ONG DI	RECTION			3
FLOOR LEVEL MARK	MARK	THICKNESS	REBAR	CON	TINUOUS	MID	SPAN	DISCO	NTINUOUS	REBAR	CON	TINUOUS	MID	SPAN	DISCO	NTINUOUS	REMARKS
		1	(mm Ø)	TOP	воттом	TOP	воттом	TOP	воттом	(mm @)	TOP	воттом	TOP	воттом	TOP	воттом	
	S-1	150	Ø12mm	150	150	150	150	150	150	Ø12mm	150	150	150	150	150	150	1-WAY SLAB
2F	S-2	150	Ø12mm	150	150	150	150	150	150	Ø12mm	150	150	150	150	150	150	2-WAY SLAB



REPUBLIC OF THE PHILIPPINES

COMMISSION ON AUDIT

REGIONAL OFFICE NO. IX

CABATANGAN, ZAMBOANGA CITY

PROJECT & LOCATION:

RECOMMENDING APPROVAL:

APPROVED (BY THE AUTORITY OF THE CHAIRPERSON):

VISITACION Q. MENDOZA
DIRECTOR IV - REGIONAL DIRECTOR

PREPARED:

AMELIA P. VALDEZ
DIRECTOR IV - GENERAL SERVICES OFFICE

LORNA D. CABOCHAN
ASSISTANT COMMISSIONER - ADMINISTRATION SECTOR

REPUBLIC OF THE PHILIPPINES

DEPARTMENT OF PUBLIC WORKS AND HIGHWAYS

REGIONAL OFFICE IX

VETERANS AVENUE EXT., TETUAN, ZAMBOANGA CITY

COA REGIONAL OFFICE NO. IX
TRAINING CENTER AND
DORMITORY BUILDING
CABATANGAN, ZAMBOANGA CITY

SHEET CONTENT:

SECOND FLOOR FRAMING PLAN

SCHEDULE OF MAIN BEAMS

SCHEDULE OF SECONDARY BEAMS

SCHEDULE OF SLABS

TYPICAL BEAM ELEVATION

JULMALI A AHIYAL
ENSINEER II
REGISTERED CIVIL ENGINEER

PIO MARIO T. LACASTESANTOS
ENGINEER III
CHIEF, BRIDGE & OTHER PUBLIC WORKS DESIGN SECTION

REVIEWED:

SUBMITTED:

RECOMMENDED:


SATURNINO C. TORREFRANCA
DISTRICT ENGINEER

OIC CHIEF, PLANNING & DESIGN DIVISION


ASSISTANT REGIONAL DIRECTOR


CAYAMOMBAO D. DIA, CESO IV

APPROVED:

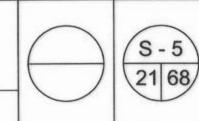

SHEET NO .:

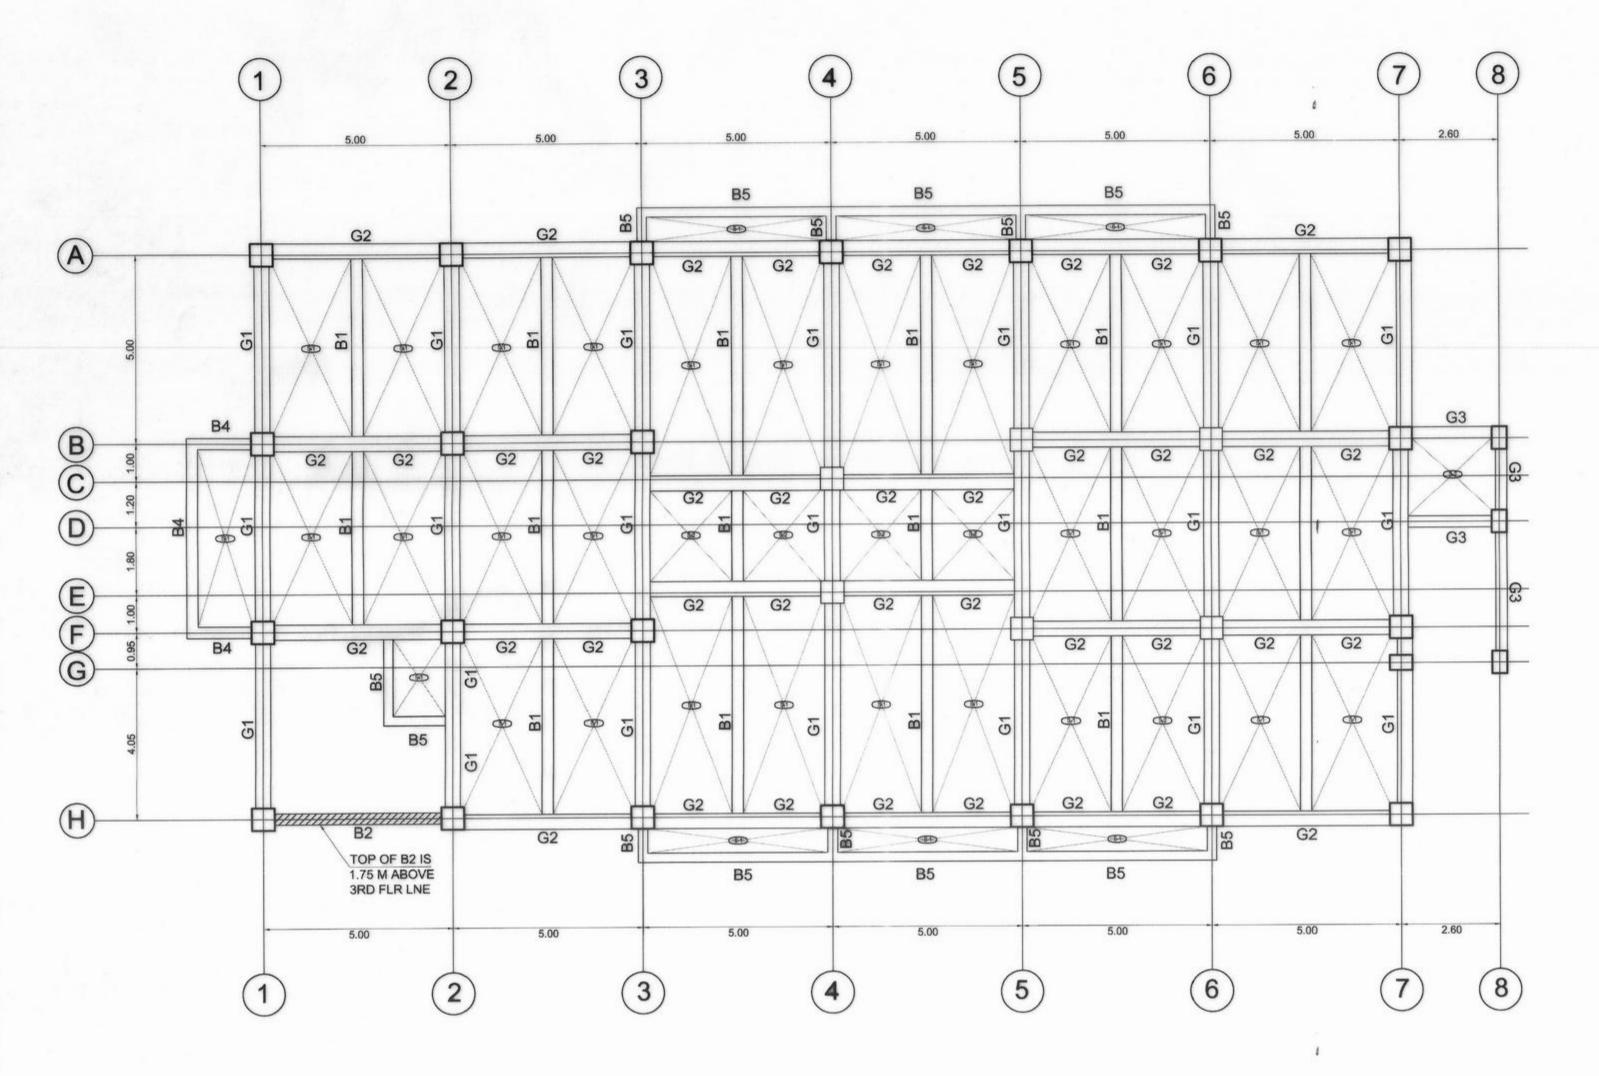

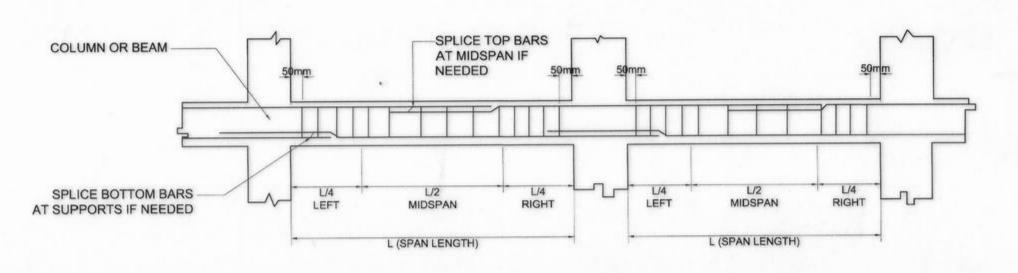

TYPICAL BEAM ELEVATION NTS

				S	CHEC	DULE C	OF M	AIN BE	EAM	S		
		100000000000000000000000000000000000000	EAM		8	STEEL	REIN	FORCE	MEN	TS		STIRRUPS
FLOOR	L MARK (In/mm)			REBAR	LEF	Т	MIC	SPAN	RIGHT		STIFFENER	
	02 MONTO 10-25	В	D	(mm Ø)	TOP	воттом	TOP	воттом	TOP	воттом	BARS	10mmØ : 1 @50,
_	G-1	400	550	Ø20mm	10	5	5	5	10	5		3 @75, 6 @ 100,
3	G-2	400	550	Ø20mm	12	6	6	6	12	6	2 - 12mm Ø	REST AT 150 TO 9
35	G-3	300	450	Ø20mm	4	2	2	2	4	2		

			S	CHEDI	JLE (OF SE	CON	DARY	BEA	MS		
			EAM		ST	EEL RI	EINF	ORCEN	IENT	S		STIRRUPS
FLOOR	BEAM MARK	(in/m	NSIONS m)	REBAR	LEF	т	MID	SPAN	RI	GHT	STIFFENER	
		В	D	(mm Ø)	TOP	воттом	TOP	воттом	TOP	воттом	BARS	
7	B-1	300	450	Ø20mm	6	4	4	4	6	4		10mmØ : 1 @5O, 3 @75,
	B-2	300	450	Ø20mm	5	4	4	4	5	4	2 - 12mm Ø	6 @ 100, REST AT
35	B-4	300	450	Ø20mm	6	3	3	3	6	3	2 - 1211111110	150 TO €
	B-5	250	400	Ø20mm	4	2	2	2	4	2		

THIRD FLOOR FRAMING PLAN

							SC	HED	ULE (OF SL	ABS						
T		T		A	LONG SH	ORT DI	RECTION					ALONG LO	ONG D	RECTION			
LOOR MARK	THICKNESS	REBAR	CON	TINUOUS	MID	SPAN	DISCO	NTINUOUS	REBAR	CON	TINUOUS	MIE	SPAN	DISCO	NTINUOUS	REMARKS	
			(mm Ø)	TOP	воттом	TOP	воттом	TOP	воттом	(mm Ø)	TOP	воттом	TOP	воттом	TOP	воттом	
	S-1	150	Ø12mm	150	150	150	150	150	150	Ø12mm	150	150	150	150	150	150	1-WAY SLAB
3F	S-2	150	Ø12mm	150	150	150	150	150	150	Ø12mm	150	150	150	150	150	150	2-WAY SLAB



REPUBLIC OF THE PHILIPPINES
COMMISSION ON AUDIT
REGIONAL OFFICE NO. IX
CABATANGAN, ZAMBOANGA CITY

PROJECT & LOCATION:

RECOMMENDING APPROVAL:

AMELIA P. VALDEZ
DIRECTOR IV - GENERAL SERVICES OFFICE

SUBMITTED:

APPROVED (BY THE AUTORITY OF THE CHAIRPERSON):

REPUBLIC OF THE PHILIPPINES

DEPARTMENT OF PUBLIC WORKS AND HIGHWAYS

REGIONAL OFFICE IX

VETERANS AVENUE EXT., TETUAN, ZAMBOANGA CITY

COA REGIONAL OFFICE NO. IX TRAINING CENTER AND DORMITORY BUILDING

CABATANGAN, ZAMBOANGA CITY

SHEET CONTENT:

THIRD FLOOR FRAMING PLAN

SCHEDULE OF MAIN BEAMS

SCHEDULE OF SECONDARY BEAMS

SCHEDULE OF SLABS

TYPICAL BEAM ELEVATION

JULMALI A. AHIYAL ENGINEER II REGISTERED CIVIL ENGINEER

VISITACION Q. MENDOZA DIRECTOR IV - REGIONAL DIRECTOR

PIO MARIO T LACASTESANTOS
ENGINEER III
CHIEF, BRIDGE & OTHER PUBLIC WORKS DESIGN SECTION

REVIEWED:

SATURNINO C. TORREFRANCA
DISTRICT ENGINEER
OIC - CHIEF, PLANNING & DESIGN DIVISION

RECOMMENDED:

KHADAFFY D. TANGGOL

ASSISTANT REGIONAL DIRECTOR

CAYAMOMBAO D. DIA, CESO IV


REGIONAL DIRECTOR


LORNA D. CABOCHAN
ASSISTANT COMMISSIONER - ADMINISTRATION SECTOR


SHEET NO .:

S-6

22 68

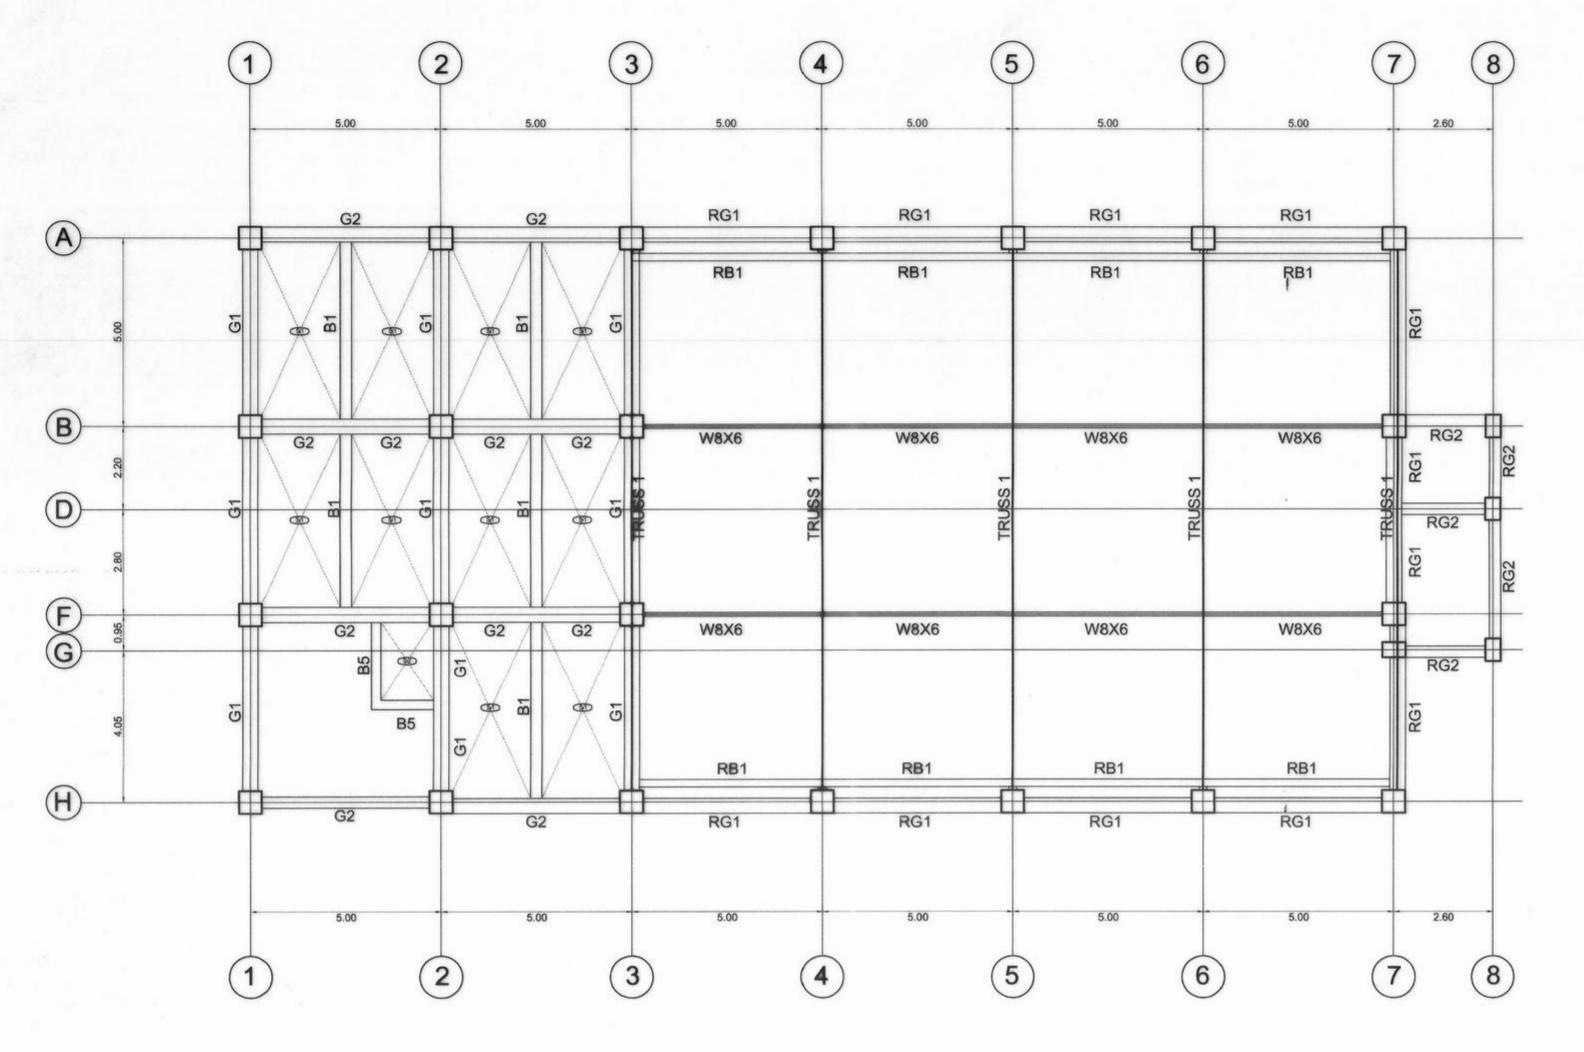

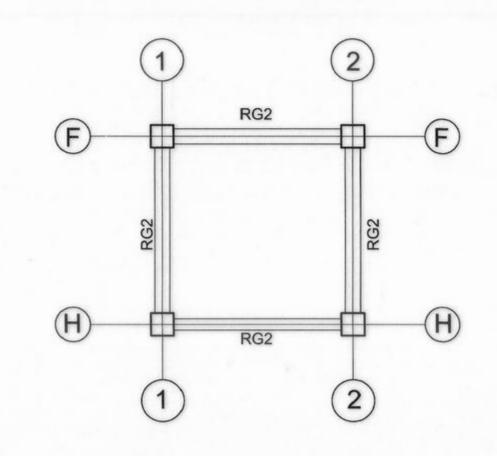

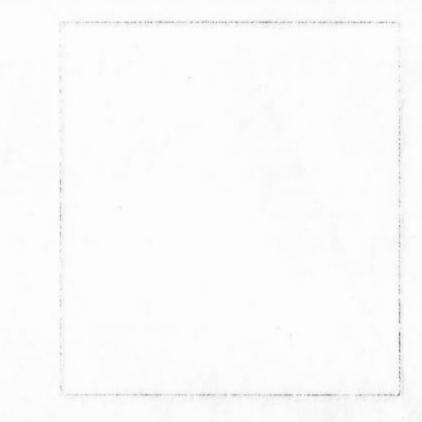

ROOF FRAMING PLAN

				SC	CHEC	DULE (OF M	AIN BE	EAM	S		
		111111111111111111111111111111111111111	EAM		s	TEEL R	EINF	ORCE	MENT	rs	-	STIRRUPS
FLOOR LEVEL	BEAM MARK	(in/m	NSIONS im)	REBAR	LEF	т	MID	SPAN	RI	GHT	STIFFENER	
		В	D	(mm Ø)	TOP	воттом	TOP	воттом	TOP	воттом	BARS	
	G1	400	550	Ø20mm	6	3	3	3	6	3		10mmØ : 1 @5O, 3 @75,
LEVEL	G2	400	550	Ø20mm	8	4	4	4	8	4	2 - 12mm Ø	6 @ 100, REST AT
80	RG1	400	550	Ø20mm	4	2	2	2	4	2	2 - 12mm Ø	150 TO €
~	RG2	300	450	Ø20mm	2	2	2	2	2	2		

			S	CHEDI	JLE (OF SE	CON	DARY	BEA	MS		
		11.75.00.00.00.00000	EAM	I	ST	EEL RE	EINF	ORCEM	ENT	s		STIRRUPS
FLOOR LEVEL	BEAM	(in/m	NSIONS im)	REBAR	LEF	т	MIE	SPAN	RI	GHT	STIFFENER	
	100000000000000000000000000000000000000	В	D	(mm Ø)	TOP	воттом	TOP	воттом	TOP	воттом	BARS	10mmØ: 1 @50,
ÆL	B-1	300	450	Ø20mm	4	2	2	2	4	2		3 @75, 6 @ 100,
9	B-5	250	400	Ø20mm	4	2	2	4	2	2	2 - 12mm Ø	REST AT 150 TO 6
S	RB-1	200	300	Ø20mm	6	3	3	3	6	3		

ROOF DECK FRAMING PLAN
1:100 M

	SCHEDULE OF SLABS																			
				А	LONG SH	ORT DI	RECTION					ALONG LO	ONG DI	RECTION						
FLOOR LEVEL	MARK	10.00	I constant to the second secon	THICKNESS	THICKNESS	REBAR	CON	TINUOUS	MID	SPAN	DISCO	NTINUOUS	REBAR	CON	TINUOUS	MIC	SPAN	DISCO	NTINUOUS	REMARKS
			(mm Ø)	TOP	воттом	TOP	воттом	TOP	воттом	(mm Ø)	TOP	воттом	TOP	воттом	TOP	воттом				
RD	S-1 150 Ø12mm 150 150 150 150 1							150	Ø12mm	150	150	150	150	150	150	1-WAY SLAB				



VETERANS AVENUE EXT., TETUAN, ZAMBOANGA CITY

REPUBLIC OF THE PHILIPPINES

COMMISSION ON AUDIT

REGIONAL OFFICE NO. IX

CABATANGAN, ZAMBOANGA CITY

RECOMMENDING APPROVAL:

AMELIA P. VALDEZ
DIRECTOR IV - GENERAL SERVICES OFFICE

APPROVED (BY THE AUTORITY OF THE CHAIRPERSON):

LORNA D. CABOCHAN
ASSISTANT COMMISSIONER - ADMINISTRATION SECTOR

SET NO.

REPUBLIC OF THE PHILIPPINES
PARTMENT OF PUBLIC WORKS AND HIGHWAYS
REGIONAL OFFICE IX

PROJECT & LOCATION:

COA REGIONAL TRAIN

COA REGIONAL OFFICE NO. IX TRAINING CENTER AND DORMITORY BUILDING

CABATANGAN, ZAMBOANGA CITY

SHEET CONTENT:

ROOF DECK FRAMING PLAN

ROOF BEAM PLAN

SCHEDULE OF MAIN BEAMS

SCHEDULE OF SECONDARY BEAMS

SCHEDULE OF SLABS

VISITACION Q. MENDOZA DIRECTOR IV - REGIONAL DIRECTOR

JULMALI A. AHIYAL

ENGINEER II

REGISTERED CIVIL ENGINEER

CHIEF, BRIDGE & OTHER PUBLIC WORKS DESIGN SECTION

REVIEWED:

SATURNINO C. TORREFRANCA
DISTRICT ENGINEER
OIC CHIEF, PLANNING & DESIGN DIVISION

SUBMITTED:


KHADAFFY D. TANGGOL
ASSISTANT REGIONAL DIRECTOR


CAYAMOMBAO D. DIA, CESO IV


APPROVED:

S-7 23 68


SHEET NO .:

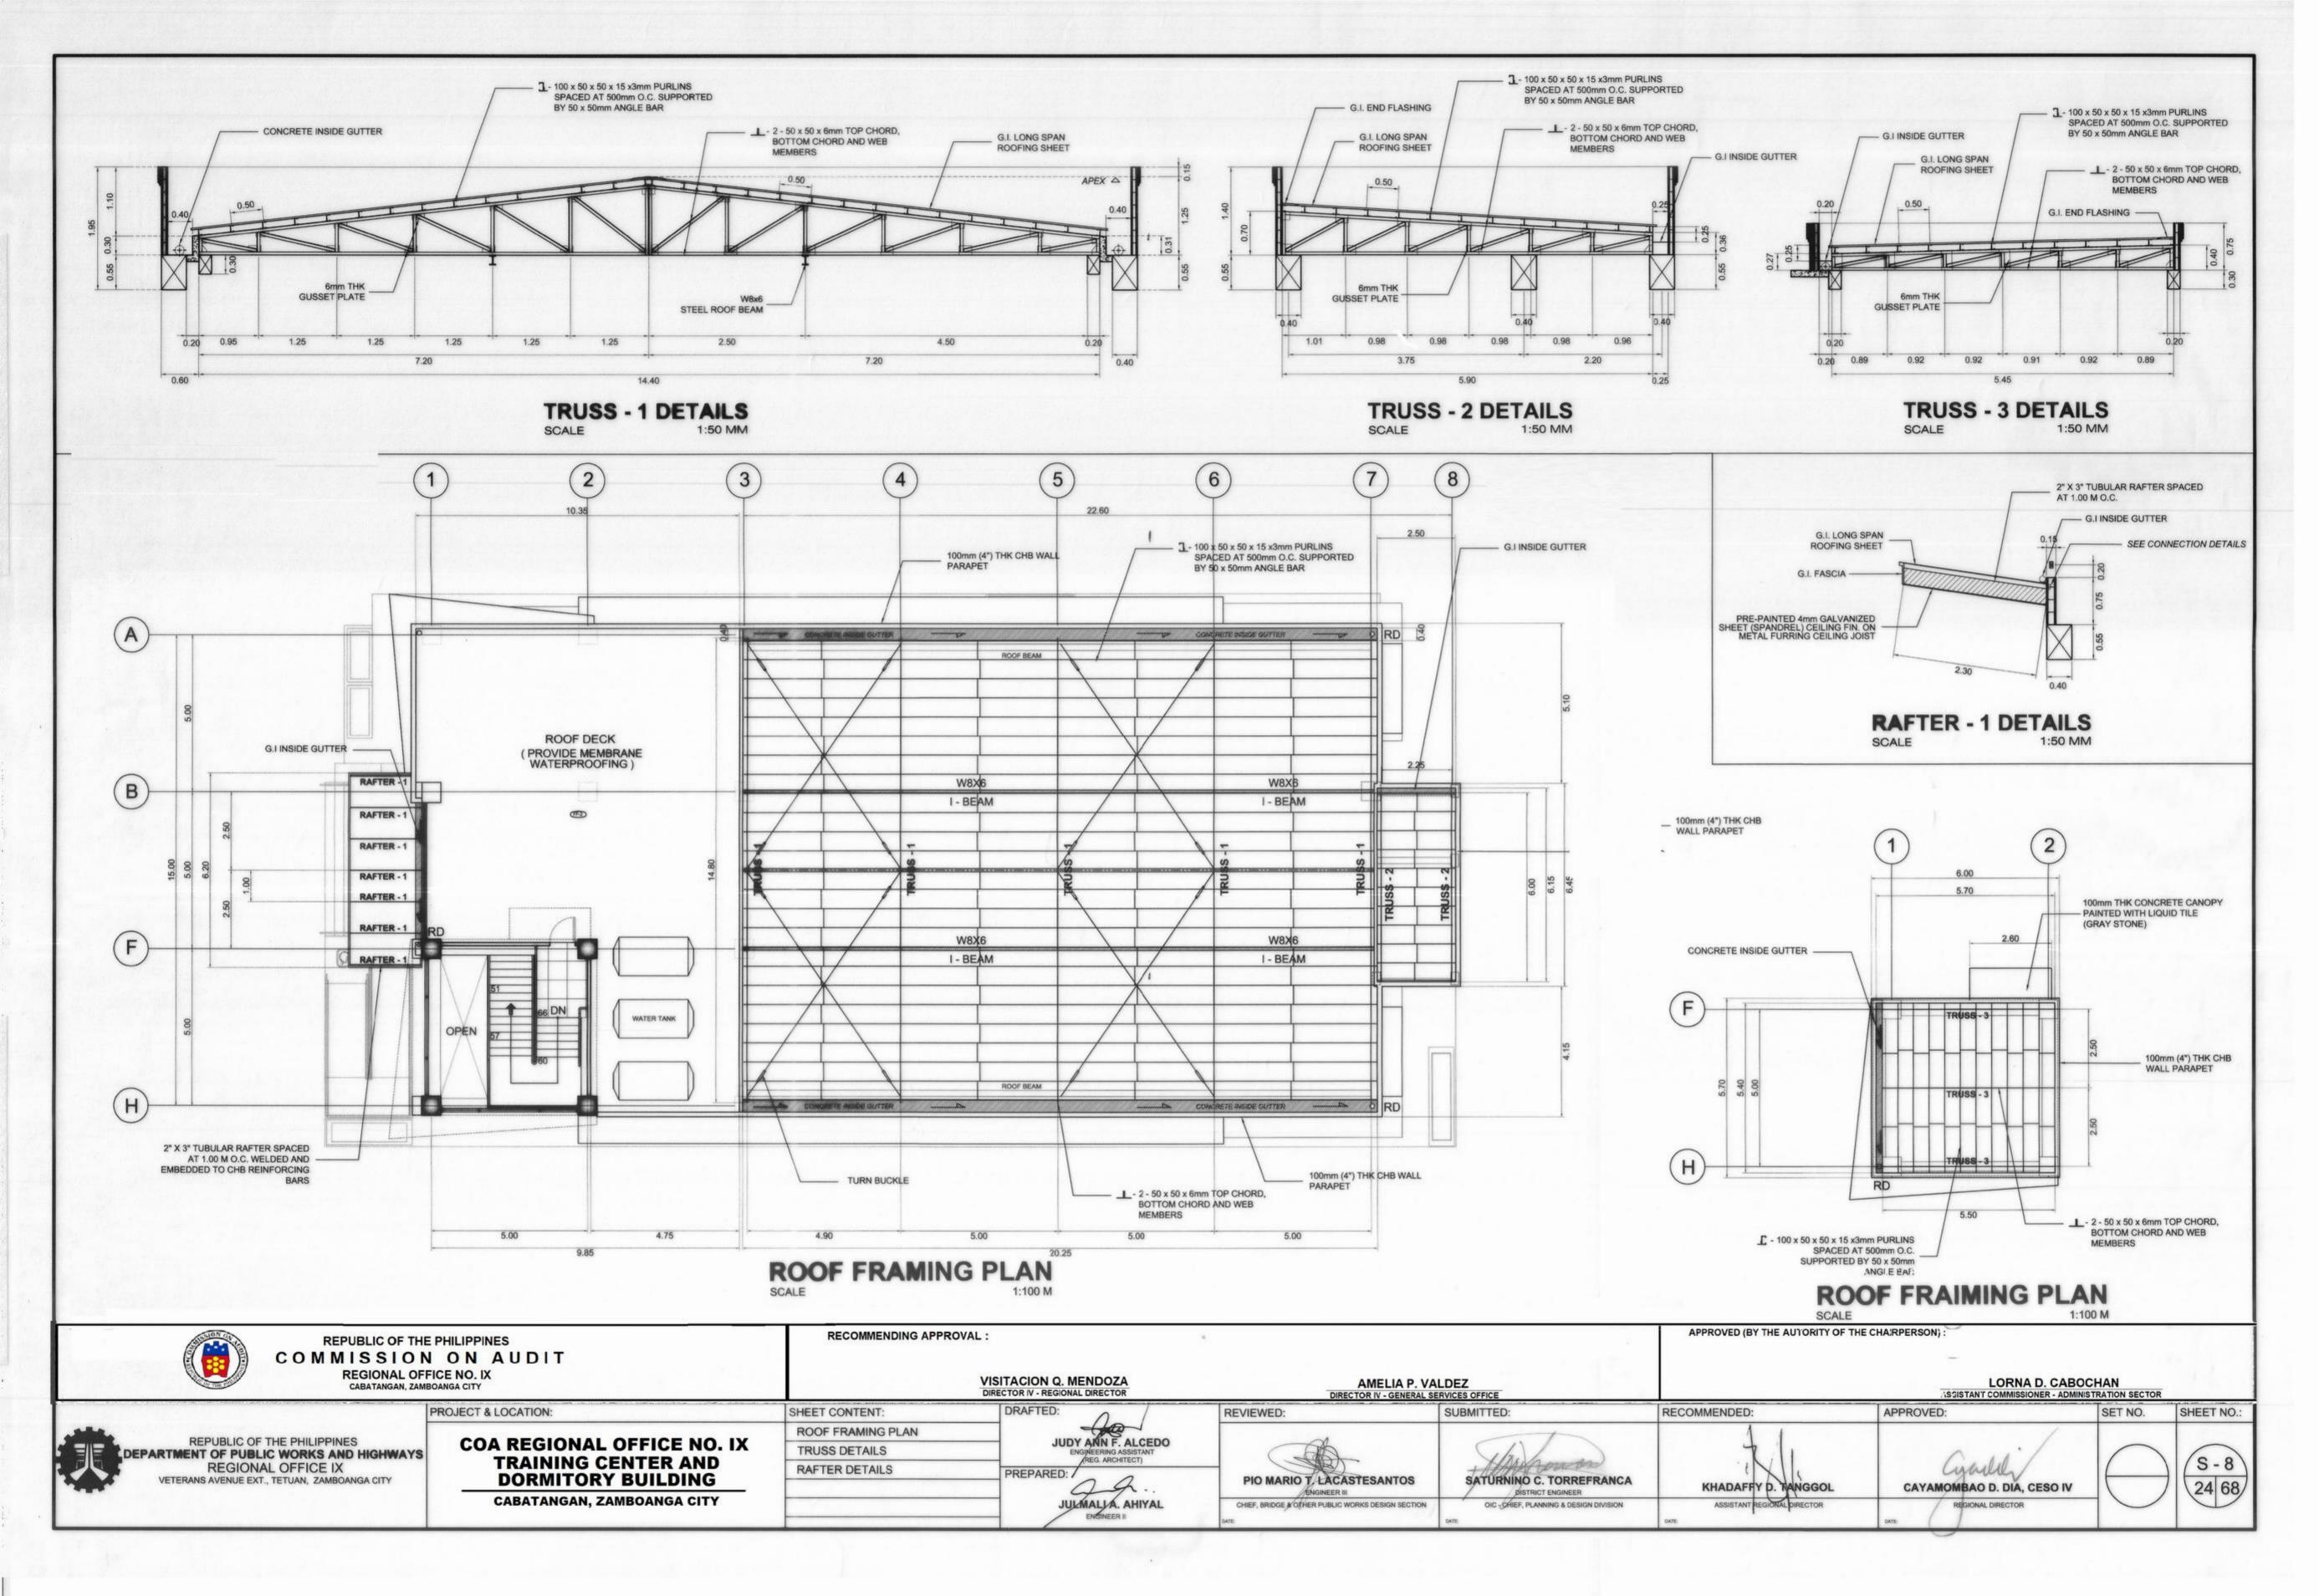

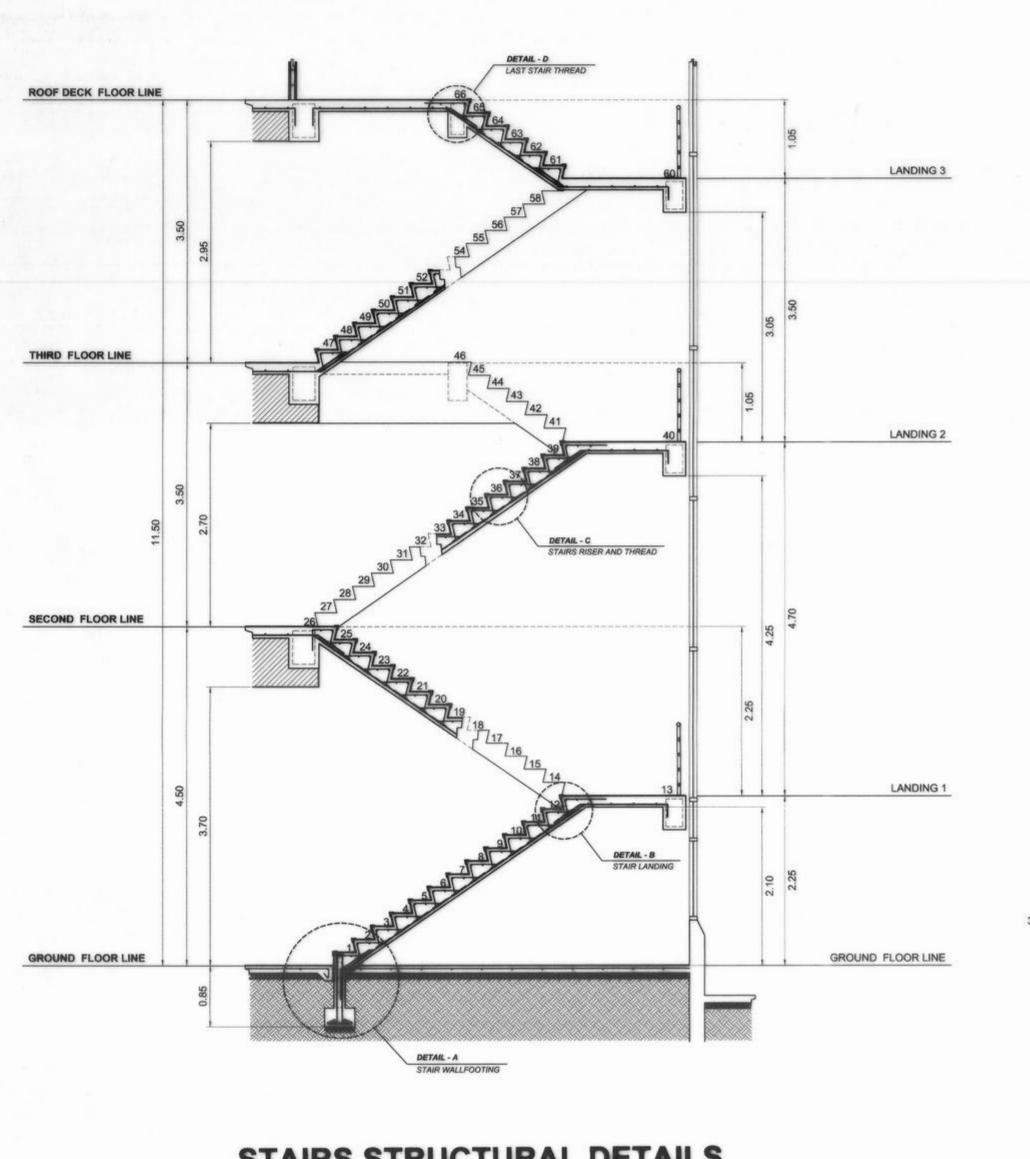


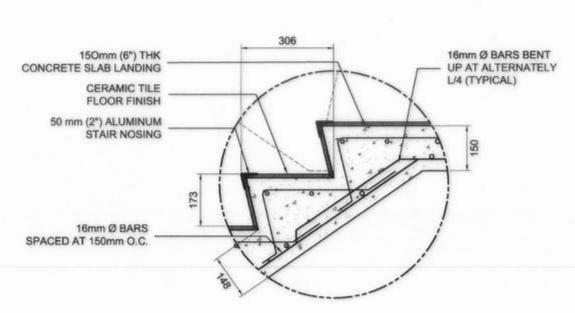


DETAIL - B STAIR LANDING

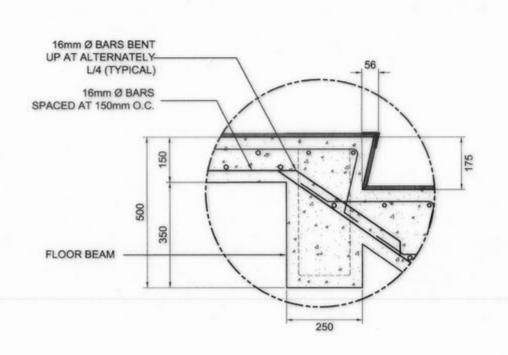


DETAIL - D LAST STAIR THREAD SCALE 1:12.5 MM

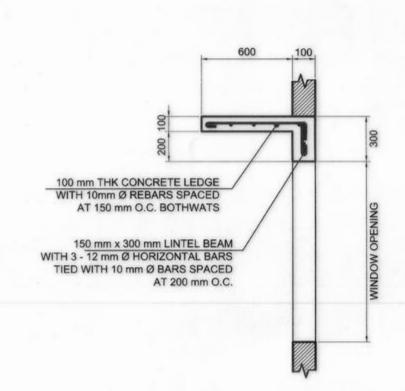

CANOPY DETAILS
SCALE 1:25 MM

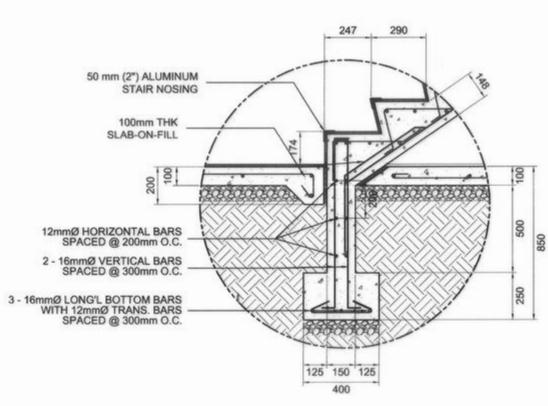

DETAIL - A STAIR WALL FOOTING

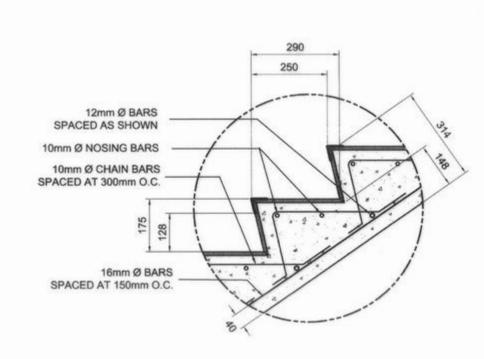

DETAIL - C RISER AND THREAD SCALE

RECOMMENDED:

STAIRS STRUCTURAL DETAILS

REPUBLIC OF THE PHILIPPINES COMMISSION ON AUDIT REGIONAL OFFICE NO. IX CABATANGAN, ZAMBOANGA CITY

RECOMMENDING APPROVAL:

REVIEWED:

AMELIA P. VALDEZ DIRECTOR IV - GENERAL SERVICES OFFICE

SUBMITTED:

APPROVED (BY THE AUTORITY OF THE CHAIRPERSON)

LORNA D. CABOCHAN
ASSISTANT COMMISSIONER - ADMINISTRATION SECTOR

REPUBLIC OF THE PHILIPPINES PARTMENT OF PUBLIC WORKS AND HIGHWAYS REGIONAL OFFICE IX VETERANS AVENUE EXT., TETUAN, ZAMBOANGA CITY

PROJECT & LOCATION: COA REGIONAL OFFICE NO. IX **TRAINING CENTER AND** DORMITORY BUILDING CABATANGAN, ZAMBOANGA CITY

SHEET CONTENT: STAIRS STRUCTURAL DETAILS STAIRS SPOT DETAILS **CANOPY DETAILS**

DRAFTED: JUDY ANN F. ALCEDO PREPARED:

VISITACION Q. MENDOZA DIRECTOR IV - REGIONAL DIRECTOR


JULMALI A. AHIYAL ENGINEER III

PIO MARIO T. LACASTESANTOS CHIEF, BRIDGE & OTHER PUBLIC WORKS DESIGN SECTION SATURNINO C. TORREFRANCA DISTRICT ENGINEER OIC CHIEF, PLANNING & DESIGN DIVISION

KHADAFFY D. TANGGOL ASSISTANT REGIONAL DIRECTOR

CAYAMOMBAO D. DIA, CESO IV REGIONAL DIRECTOR

APPROVED:

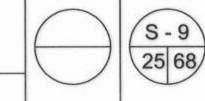

SET NO.

SHEET NO .: